

## **Interoffice Memorandum**

Revised Request Received on July 29, 2024

Deadline: August 6, 2024 Publish: August 11, 2024

July 15, 2024

To: Jennifer Lara-Klimetz, Assistant Manager

Comptroller Clerk's Office

Cheryl Gillespie, Agenda Development Supervisor Through:

Agenda Development

From:

Environmental Protection Division Lenui Henri Henri (407) 836-1420

**Staff Person:** Elizabeth R. Johnson, CEP, Assistant Manager

**Environmental Protection Division** 

(407) 836-1511

Subject: Request for Public Hearing on August 27, 2024, at 2:00 p.m., for a

> Shoreline Alteration/Dredge and Fill Permit Application (SADF-24-06-013) to authorize the construction of a replacement aluminum sheet pile seawall along the shoreline of Lake Weston at 5808 Satel Drive, Orlando,

Florida, 32810, Parcel ID No. 34-21-29-0314-02-590; District 2

Applicant: Barbara A. Neel Life Estate, REM: Barbara Ann Neel

Shoreline Alteration/Dredge and Fill Permit Application Type of Hearing:

Hearing required by

Florida Statute # or Code: Chapter 15, Article VI, Pumping and Dredging Control

Publish once in a newspaper of general circulation in Orange Advertising requirements:

County at least (7) seven days prior to public hearing.

Advertising timeframes: At least (7) seven days prior to public hearing.

Abutters to be notified: The applicant and the property owners within 500 feet of the

project area will be notified at least (7) seven days prior to public

hearing by the Environmental Protection Division (EPD).

Estimated time required

For public hearing: 2 minutes Page 2 July 15, 2024

Request for Public Hearing – Shoreline Alteration/Dredge and Fill Permit Application for Barbara A. Neel Life Estate, REM: Barbara Ann Neel (SADF-24-06-013)

Municipality or other Public Agency to be

notified: Florida Department of Environmental Protection,

DEP CD@dep.state.fl.us

Hearing Controversial: No

District #: 2

Materials being submitted as backup for public hearing request:

- 1. Location Map
- 2. Site Plans
- 3. Site Photos

### Special Instructions to Clerk:

1. Once the Board of County Commissioners makes a decision on the Shoreline Alteration/Dredge and Fill Permit Application, please submit the decision letter to Liz Johnson with EPD. EPD will issue the decision to the applicant.


# Advertising Language:

1. Applicant, Barbara A. Neel Life Estate, REM: Barbara Ann Neel, is requesting a Shoreline Alteration/Dredge and Fill Permit Application (SADF-24-06-013) to authorize the construction of a replacement aluminum sheet pile seawall along the shoreline of Lake Weston at 5808 Satel Drive, Orlando, Florida, 32810, pursuant to Chapter 15, Article VI, Pumping and Dredging Control; Parcel ID No. 34-21-29-0314-02-590; District 2 (property legal description on file at EPD).

### ER/KGK/TMH/ERJ/RHP:rt

Attachments

# **Shoreline Alteration/Dredge and Fill Permit Request**

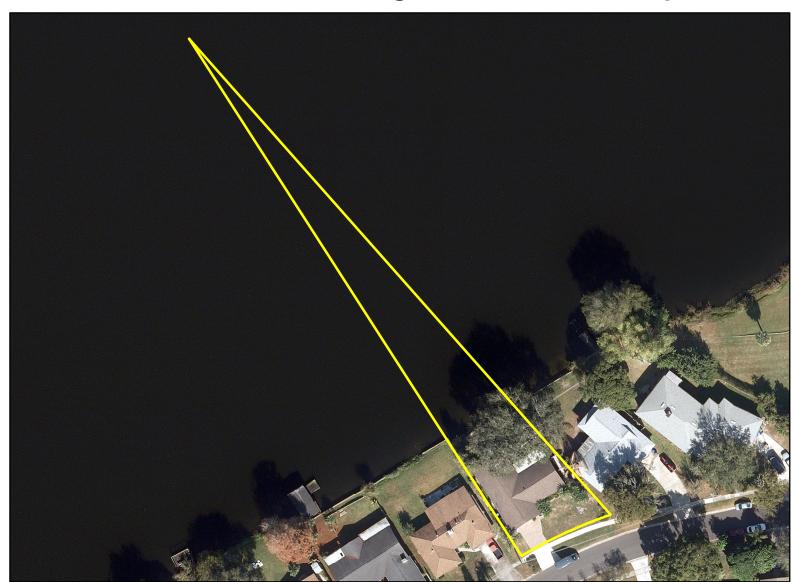

Shoreline Alteration/Dredge and Fill Permit Request

SADF-24-06-013

District #2

Applicant: Barbara A. Neel Life Est.

**REM: Barbara Ann Neel** 


Address: 5808 Satel Drive


Parcel ID: 34-21-29-0314-02-590


**Project Site:** 


**Property Location:** 




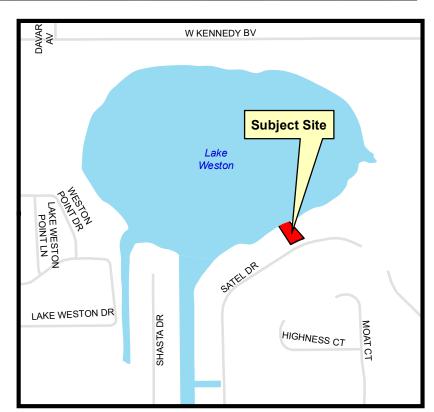

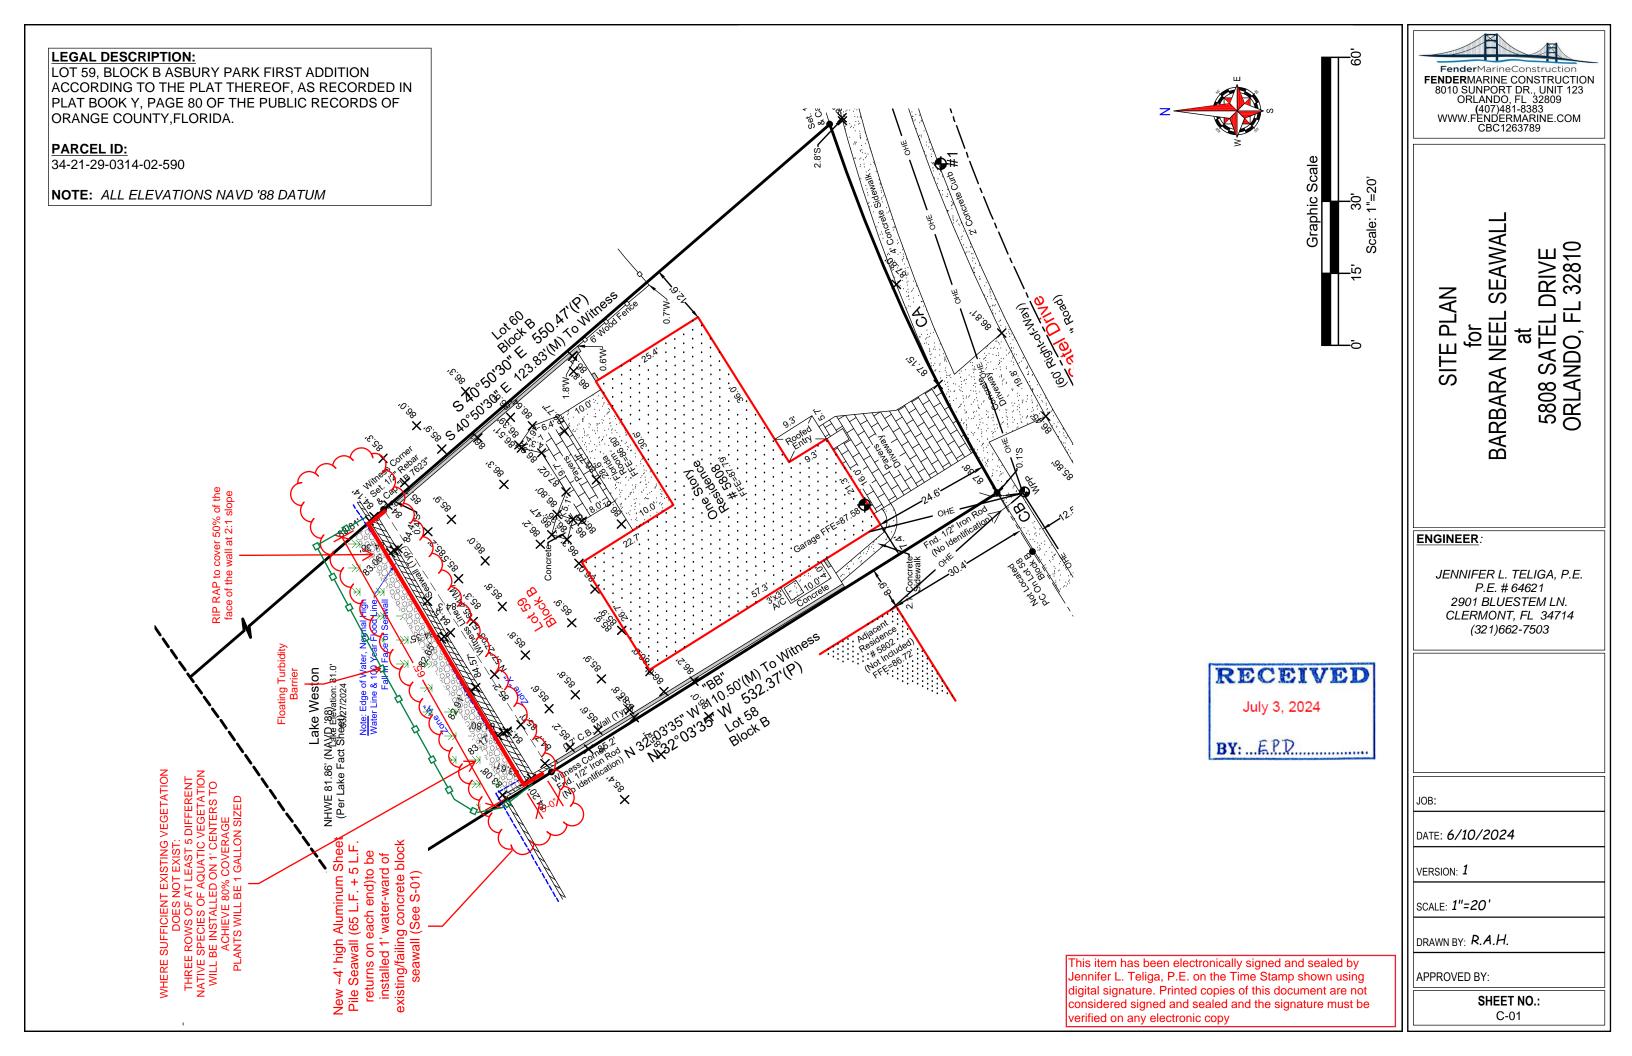

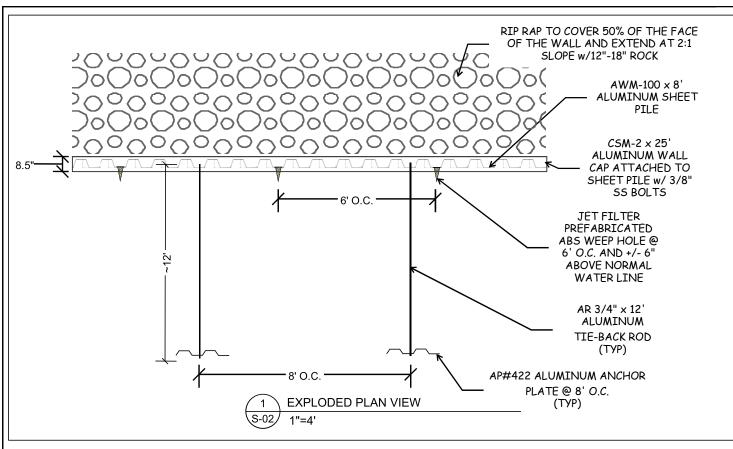

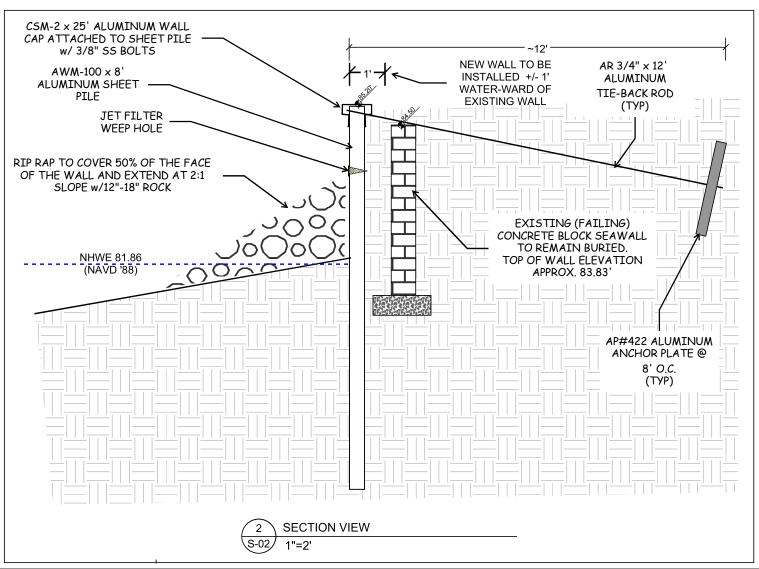

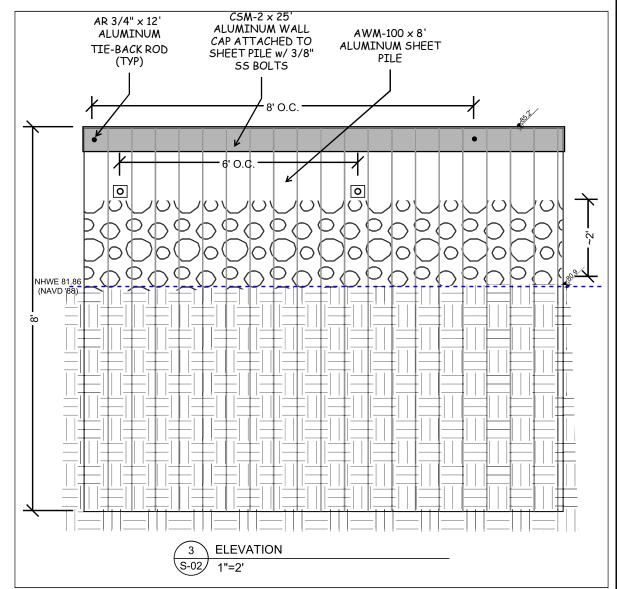



FenderMarineConstruction
FENDERMARINE CONSTRUCTION
8010 SUNPORT DR., UNIT 123
ORLANDO, FL 32809
(407)481-8383
WWW.FENDERMARINE.COM
CBC1263789

STRUCTURAL PLANS for BARBARA NEEL SEAWALL at 5808 SATEL DRIVE ORLANDO, FL 32810

### ENGINEER:

JENNIFER L. TELIGA, P.E. P.E. # 64621 2901 BLUESTEM LN. CLERMONT, FL 34714 (321)662-7503

Digitally signed by JENNIFER
TELIGA
Date:
2024.07.03
14:36:02 -04'00'

This item has been electronically signed and sealed by Jennifer L. Teliga, P.E. on the Time Stamp shown using digital signature. Printed copies of this document are not considered signed and sealed and the signature must be verified on any electronic copy

JOI

DATE: 6/10/2024

VERSION: 1

SCALE: NTS

DRAWN BY: R.A.H.

APPROVED BY:

SHEET NO.: S-02

#### **GENERAL REQUIREMENTS**

REPRODUCTIONS OF CONTRACT DRAWINGS BY CONTRACTOR IN LIEU OF PREPARATION OF SHOP DRAWINGS SIGNIFIES ACCEPTANCE OF INFORMATION SHOWN AS CORRECT AND OBLIGATES HIMSELF TO ANY EXPENSE, REAL OR IMPLIED, ARISING FROM THEIR USE. A CHANGE TO THE STRUCTURAL DRAWINGS DUE TO THE ACCEPTANCE OF ALTERNATES AND/OR SUBSTITUTES IS THE RESPONSIBILITY OF THE CONTRACTOR AND MUST BE SUBMITTED TO THE ENGINEER FOR APPROVAL. THE GENERAL CONTRACTOR AND EACH SUBCONTRACTOR SHALL VERIFY ALL EXISTING CONDITIONS PRIOR TO STAT OF ANY WORK. ALL INCONSISTENCIES SHALL BE REPORTED TO THE DESIGNER AND/OR STRUCTURAL ENGINEER, IF NEEDED, SHOULD CONTRACTOR CONSTRUCT THE PREMISES IN A FASHION NOT CONSISTENT WITH THE PLANS PREPARED BY THE DESIGNER AND/OR STRUCTURAL ENGINEER, THEN DESIGNER AND/OR STRUCTURAL ENGINEER SHALL BEAR NO RESPONSIBILITY OR LIABILITY FOR THE CONSTRUCTION OF PREMISES AND ACCURACY OF THE DRAWINGS

#### APPLICABLE CODES AND STANDARDS

CONSTRUCTION SHALL CONFORM TO THE REQUIREMENTS OF THESE STRUCTURAL SPECIFICATIONS AND THE REQUIREMENTS CONTAINED IN THE FOLLOWING CODES AND STANDARDS. WHEN A DIFFERENCE EXISTS BETWEEN THESE SPECIFICATIONS AND ANY OTHER GOVERNING CODE, THE MORE STRINGENT SHALL CONTROL. ANY OTHER ITEMS NOT COVERED THEREIN SHALL BE COMMENSURATE WITH SOUND ENGINEERING AND STANDARD CONSTRUCTION PRACTICES

#### FLORIDA BUILDING CODE 2023, 8th EDITION

AMERICAN WOOD COUNCIL - NATIONAL DESIGN SPECIFICATIONS FOR WOOD CONSTRUCTION 1997 EDITION AMERICAN SOCIETY OF CIVIL ENGINEERS (ASCE 7-22) MINIMUM DESIGN LOADS FOR BUILDINGS AND OTHER STRUCTURES.


#### **DESIGN LOADS**

PURSUANT TO CHAPTER 1609 LL (-TABLE 1607, WL-SECTION 1609)
ULTIMATE WIND: 150 MPH AT 3 SECOND GUST (30 PSF MINIMUM)
RISK CATEGORY II (TABLE 1604-5)
EXPOSURE CATEGORY "D" (FBC 1609.4.3 AND ASCE 7-10, SECTION 26.7.2)
DECK LIVE LOAD: 100 PSF
DEAD LOAD: 10 PSF
COMPONENTS AND CLADDING DESIGN WIND PRESSURES: +38 PSF/-38PSF

OPEN STRUCTURE WITH A ZERO PRESSURE COEFFICIENT

#### **GENERAL NOTES**

- 1. DETAILS SHOWN ON PLANS MAY BE FOR TYPICAL CONDITIONS. FOR CONDITIONS NOT SHOWS, PROVIDE DETAILS OF A SIMILAR NATURE.
- 2. DIMENSIONS SHOWN ON THESE PLANS SHALL BE VERIFIED BY THE CONTRACTOR OR BUILDER PRIOR TO CONSTRUCTION. THESE PLANS MAY NOT BE DRAWN TO SCALE. SCALING OF DRAWINGS IS STRONGLY DISCOURAGED. DIMENSIONED DRAWINGS TAKE PRECEDENCE OVER SCALED. IF CONFLICTS EXIST IN THE DRAWINGS, THE MORE STRINGENT SHALL PREVAIL.
- 3. THE CONTRACTOR SHALL COORDINATE ALL NEW WORK WITHE THE EXISTING CONDITION AND SHALL REPORT ANY DISCREPANCIES TO THE ENGINEER AND OWNER.
- 4. OBTAIN APPROVAL FROM THE ENGINEER PRIOR TO ALL STRUCTURAL CHANGES.
- 5. CONTRACTOR IS RESPONSIBLE FOR ALL CONSTRUCTION PRACTICES, INCLUDING TECHNIQUES, PROCEDURES, SHORING AND THE SEQUENCE OF CONSTRUCTION. CONTRACTOR SHOULD NOTIFY ENGINEER IF A CONFLICT ARISES DUE TO VARIATIONS OR OTHER PROBLEMS WITH THE CONSTRUCTION DOCUMENTS.
- 6. SURVEY AND WETLAND INFORMATION IS PROVIDED TO ENGINEER AND IS PORTRAYED FOR CONCEPTUAL LOCATION ONLY. DISPLAY DOES NOT CONSTITUTE REVIEW ACCEPTANCE OR ENDORSEMENT OF INFORMATION CONTAINED THEREIN. (BASED ON PROPERTY SURVEY BY OTHERS)

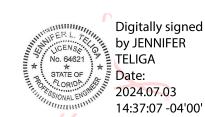

This item has been electronically signed and sealed by Jennifer L. Teliga, P.E. on the Time Stamp shown using digital signature. Printed copies of this document are not considered signed and sealed and the signature must be verified on any electronic copy



GENERAL NOTES for BARBARA NEEL SEAWALL at 5808 SATEL DRIVE ORLANDO, FL 32810

### **ENGINEER**:

JENNIFER L. TELIGA, P.E. P.E. # 64621 2901 BLUESTEM LN. CLERMONT, FL 34714 (321)662-7503

)B	
JВ	

DATE: 6/10/2024


VERSION: 1

SCALE: NTS

DRAWN BY: R.A.H.

APPROVED BY:


SHEET NO.: S-04

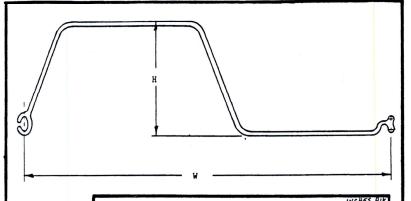

	INCHES PIK SECTION PROPERTIES PER LINEAL FOOT OF WALLX 17 + 1000						
DESIGNATION	H INCHES	W INCHES	THICKNESS INCHES	MOMENT INERTIA INCHES <sup>14</sup>	SECTION MODULUS INCHES <sup>3</sup>	MOMENT CAPACITY FOOT-LBS	
AWL-100 AWL-125 AWL-135	2.5 2.5 2.5	12 12 12	0.100 0.125 0.135	1.60 1.95 2.18	1.258 1.542 1.714	1992 2441 2714	
AWM-100 AWM-125 PZM-160 PZM-190	4.0 4.0 4.0	12 12 12 12	0.100 0.125 0.160 0.188	4.44 5.99 7.42 8.58	2.200 2.967 3.71 4.29	3483 4694 5875 6966	

- 1. Piling normally provided in 1 foot increments, however lengths such as 8.5' or 13.3' can be provided upon request.
  All the above listed sections interlock with each other.
- Section AWM-150 and AWM-188 are not listed. For information on these sections, please contact RAVENS.
- The AWL series of sheeting has its own cap and hardware. Be
- sure to speify the CSL and BAL sections. The AWM series of sheeting has its own cap and hareware. Be
- sure to specify the CSM and BAM sections.
  Section AWM-150 interlocks with section PZH-150 and the section AWM-188 interlocks with sections PZH-188 & PZH-250.

ALLOY 6061-T6 SHEET PILING SECTIONS E-2

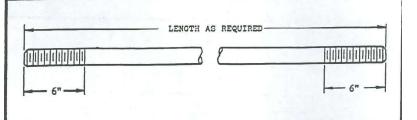


DIAMETER & THREAD SIZE			MAXIMUM PULL POUNDS	
3/4 - 10 7/8 - 9 1 - 8 1-1/8 - 7 1-1/4 - 7 1-1/2 - 6 1-3/4 - 5 2 - 4½	20 FT 30 FT 30 FT 40 FT 40 FT 40 FT 40 FT	0.334 0.462 0.606 0.763 0.969 1.405 1.900 2.500	6340 8770 11510 14490 18410 26690 36100 47500	

- Threads are UNC Series 2A.
- Nuts are Aluminum Association Standard Class 2B free fit. Stainless steel nuts of the same dimension may be substituted.
- Rod lengths vary in 2 foot increments.
- Special lengths of rods are subject to inquiry.
- Shorter or longer threading on the ends of the rods can be accomplished by requesting it prior to fabrication.
- Threaded ends to have wax over them.

--- NOTICE --IT IS NECESSARY TO FOLLOW ALL INSTALLATION INSTRUCTIONS FOR THE
INSTALLATION OF TIE RODS OTHERWISE DAMMAGE MAY OCCUR TO THE

E-21 ANCHOR ROD DETAIL ALLOY 6061-T6

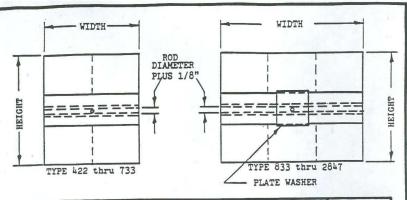

	HEIGHT	WIDTH	ROD	CAPACITY	SHEETING	CHAN	NELS
TYPE	IN	IN	SIZE	POUNDS	TYPE & ALLOY	NO.	TYPE
422 522 632 733 833 933 1234 1644 2045 2446 2847	24 30 24 30 33 36 48 48 60 72	8888999955	3/4 3/4 7/8 1 1-1/8 1-1/4 1-1/2 1-3/4 2 2	6300 6300 8560 11490 11490 18400 26300 36100 47500 47500	AWL-100 3 AWL-100 3 AWL-100 3 AWL-100 1 AWL-125 1 AWM-125 1 AWM-125 1 AWM-125 1 PZH-150 1 PZH-188 1 PZH-188 1	1 1 1 2 2 2 2 2 2 2 2 2	BB-1 BB-2 BB-3 BB-4 BB-5 BB-6 WB-8 WB-8


- Corrugations in the sheeting run parallel to the height.
  Backing beams are velded to the sheeting.
  Capacities are controlled by the rod size, backing beam(s) or the sheeting properties.
- The sheeting alloy is as follows: 1 = 6061-T6; 3 = 6063-T6 Smaller rods may be used with larger plates by giving
- notice before fabrication. Alloy 6061-T6 may be substituted for alloy 6063-T6 by the


fabrication plant.

ALLOYS 6061-T6 & 6063-T6

ANCHOR PLATE DETAILS

E-22

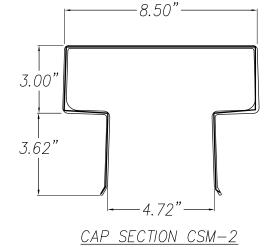

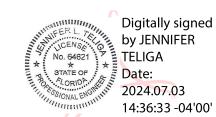

This item has been electronically signed and sealed by Jennifer L. Teliga, P.E. on the Time Stamp shown using digital signature. Printed copies of this document are not considered signed and sealed and the signature must be verified on any electronic copy



WALL COMPONENT DETAIL SEAWALL DRIVE L 32810 ت <del>آ</del> ح for BARBARA NEEL 9 at 5808 SATEL D 5808 SATEL ORLANDO, F

#### **ENGINEER:**

JENNIFER L. TELIGA, P.E. P.E. # 64621 2901 BLUESTEM LN. CLERMONT, FL 34714 (321)662-7503

DATE: 6/10/2024

VERSION: 1

SCALE: NTS

DRAWN BY: R.A.H.

APPROVED BY:

SHEET NO.: S-03

