Interoffice Memorandum



05-08-17P01:55 RCVD

May 1, 2017

TO:

Katie Smith, Manager

Comptroller Clerk's Office

05-08-17P02:20 RCVD

THROUGH:

Cheryl Gillespie, Agenda Development Supervisor

Agenda Development

FROM:

Lori Cunniff, CEP, CHMM, Deputy Director

Community, Environmental and Development Services Department

STAFF PERSON:

Elizabeth R. Johnson, Environmental Programs Administrator

Environmental Protection Division

PHONE #:

407-836-1511

SUBJECT:

Request for Public Hearing on June 20, 2017, at 2:00 p.m. for Semi-Private Boat Ramp Facility Permit No. BR-16-04-000 - Taylor Morrison of Florida, Inc., located on John Hancock Drive, Winter Garden, FL 34787, on Lake Hancock, in Section 28, Township 23 South, Range 27,

East, Parcel ID No.: 28-23-27-9174-10-000

NOTE:

Schedule this public hearing concurrently with Conservation Area

Impact Permit No. CAI-16-04-018

Applicant:

Taylor Morrison of Florida, Inc.

Type of Hearing:

Request for Semi-Private Boat Ramp Facility Permit.

Hearing required by

Florida Statute # or Code:

Chapter 15, Article XV, Section 15-605(d)(2).

Advertising requirements:

Publish once in a newspaper of general circulation in Orange

County at least fourteen (14) days prior to public hearing.

Advertising timeframes:

At least fourteen (14) days prior to public hearing.

Abutters to be notified:

The upland property owners on Lake Hancock will be notified at

least four (4) weeks prior to the public hearing by the applicant.

Lake Advisory Board

to be notified:

N/A.

Estimated time required

for public hearing:

2 minutes.

June 20,201

LEGISLATIVE FILE # 17-659

May 1, 2017
Request for Public Hearing – Taylor Morrison of Florida, Inc. Request for Semi-Private Boat Ramp Facility Permit
Page 2 of 2

Hearing Controversial:

No.

Municipality or other Public Agency to be

notified:

South Florida Water Management District - mady@sfwmd.gov

District No.:

1.

Materials being submitted as backup for public hearing request:

- 1. Site Plans
- 2. Location Map

Special Instructions to Clerk:

1. Once the Board of County Commissioners makes a decision on the Semi-Private Boat Ramp Facility Request, please submit the decision letter to Michelle Gonzalez with EPD. EPD will issue the decision to the applicant.

Advertising Language:

2. Taylor Morrison of Florida, Inc. Parcel ID No.: 28-23-27-9174-10-000. Request to construct a semi-private boat ramp facility pursuant to Chapter 15, Article XV. Lake Hancock. District 1. Legal description on file at EPD.


TMH/NT/ERJ/LC: mg

Attachments

c: Chris Testerman, Assistant County Administrator
Jon V. Weiss, P.E., Director, Community, Environmental and Development Services
Joel D. Prinsell, Deputy County Attorney

Semi-Private Boat Ramp Facility Permit Request



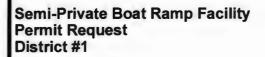

Applicant: Taylor Morrison of Florida, Inc.


Parcel ID: 28-23-27-9174-10-000

Semi-Private Boat

Ramp Permit No.: BR-16-04-000

Project Site ____

Property Location

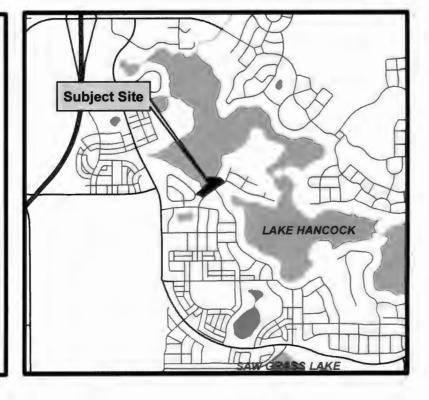




Bio-Tech Consulting Inc.
Environmental and Permitting Services
3028 E South Street Orlando, FL 32803
Pit: 407-894-5970
www.bio-technoralisting.com

Overlook Boat Ramp Orange County, Florida Impact Exhibit



0.0055
Miles
Project #:183-39
Produced By:JDH
Date: 12/1/2016

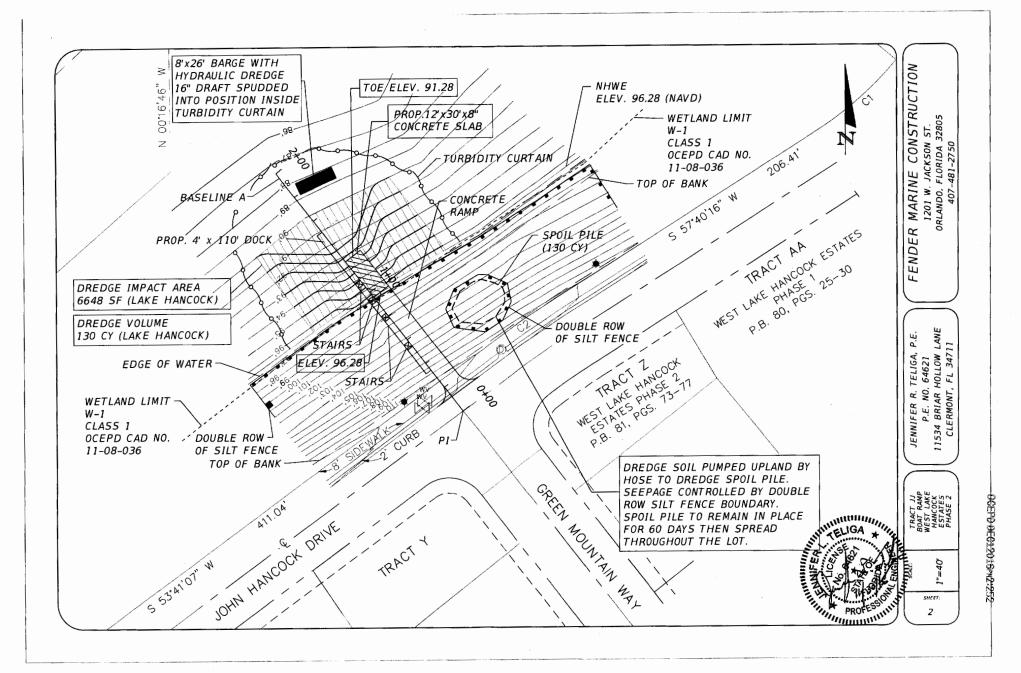

PROFESSOR

OCEPD DEC12016PH2:252

L.

JENNIFER R. TELIGA, P P.E. NO. 64621 11534 BRIAR HOLLOW L CLERMONT, FL 34711

LOCATION

DECKING TO STRINGER	2x8	2-3' SCREWS
STRINGER CROSS TIE	2x10	H4 OR EQUIV.
CROSS BRACE TO POST	2x6	3/8" x 4 1/2" LAG BOLT

AWPA RETENTION REQUIREMENTS

APPLICATION USE CATEGORY	ACO (PCF)
ABOVE GROUND	0.25
GROUND / FRESH WATER CONTACT	0.40
PERMANENT WOOD FOUNDATION	0.60
SALT WATER SPLASH	0.60
SALT WATER IMMERSION	2.50
LUMBER, TIMBERS AND PLYWOOD	
STRUCTURAL POLES	0.60
FOUNDATIONS / FRESH WATER	0.80

TYPE OF STRUCTURE	TYPE OF WORK	NUMBER OF DOCKS	LENGTH	WIDTH		SF OVER WATER	NO. OF SLIPS	SF OVER CONSERVATION AREA
TERMINAL PLATFORM	NEW	0	0				-	
TERMINAL WALKWAY	NEW	0	0				-	
WALKWAY WEDGE	NEW	0	o				-	
WALKWAY OVER WATER	NEW	0	55	4	2	220 SF	-	
CONSERVATION AREA	NEW	0	53.5	4'	3		-	214 SF
WALKWAY UPLANDS	NEW	0	55	4	3'	220 SF	-	
SQUARE FEET OVER WATER							220 SF	
SHORELINE 111.5 LF							-	

GENERAL NOTES

- 1. DETAILS SHOWN ON PLANS WAY BE FOR TYPICAL CONDITIONS. FOR CONDITIONS NOT SHOWN, PROVIDE DETAILS OF A SIMILAR NATURE.
- DIMENSIONS SHOWN ON THESE PLANS SHALL BE VERIFIED BY THE CONTRACTOR OR BUILDER
 PRIOR TO CONSTRUCTION. THESE PLANS MAY NOT BE DRAWN TO SCALE. SCALING OF DRAWINGS IS
 STRONGET DISCUBLAGED. DIMENSIONED DRAWINGS TAKE PRECEDENT OVER SCALED. IF CONFLICTS
 EXIST IN THE DRAWINGS, THE MORE STRINGENT SHALL PREVAIL.
- 3. THE CONTRACTOR SHALL COORDINATE ALL NEW WORK WITH EXISTING CONDITION AND SHALL REPORT ANY DISCREPANCIES TO THE ENGINEER AND OWNER.
- 4. OBTAIN APPROVAL FROM THE ENGINEER PRIOR TO ALL STRUCTURAL CHANGES.
- 5. CONTRACTOR IS RESPONSIBLE FOR ALL CONSTRUCTION PRACTICES, INCLUDING TECHNIQUES, PROCEDURES, SHORING AND THE SEQUENCE OF CONSTRUCTION. CONTRACTOR SHOULD NOTIFY ENGINEER IF A CONFLICT ARISES DUE TO VARIATIONS OR OTHER PROBLEMS WITH THE CONSTRUCTION
- 8. SURVEY AND WETLAND INFORMATION IS PROVIDED TO ENGINEER AND IS PORTRAYED FOR CONCEPTUAL LOCATION ONLY. DISPLAY DOES NOT CONSTITUTE REVIEW ACCEPTANCE OR ENCORSEMENT OF INFORMATION CONTINUED THEREIN. (BASED ON PROPERTY SURVEY BY OTHERS)
- HANDRAIL TO BE INSTALLED AT ALL LOCATIONS GREATER THAN 30" ABOVE ADJACENT GRADE, AND ALL OTHER LOCATIONS REQUIRED BY FLORIDA BUILDING CODE.
- 8. ALL PILES IN CONTACT WITH THE WATER SHALL BE WRAPPED IN PLASTIC TO PREVENT LEACHING OF POISONS INTO THE WATER.

APPLICABLE CODES AND STANDARDS


CONSTRUCTION SHALL CONFORM TO THE REQUIREMENTS OF THESE STRUCTURAL SPECIFICATIONS AND THE REQUIREMENTS CONTAINED IN THE FOLLOWING CODES AND STANDARDS, WHEN A DIFFERENCE EXIST BETWEEN THESE SPECIFICATIONS AND ANY OTHER GOVERNING CODE, THE MORE STRINGENT SHALL CONTROL ANY OTHER ITEMS NOT COVERED THEREIN SHALL BE COMMENSURATE WITH SOUND ENGINEERING AND STANDARD CONSTRUCTION PRACTICES.

2014 FLORIDA BUILDING CODE AISC KANUAL OF STEEL CONSTRUCTION AMERICAN CONCRETE INSTITUTE (AC) 318-02) AMERICAN WOOD COUNCIL - NATIONAL DESIGN SPECIFICATIONS FOR WOOD CONSTRUCTION 1997 AMERICAN SOCIETY OF CIVIL ENGINEERS (ASCE 7-02) MINIMUM DESIGN LOADS FOR BUILDINGS AND OTHER STRUCTURES.


DECK LIVE LOAD 40 PSF WIND SPEED 139 MPH EXPOSURE "B" INTERNAL PRESSURE COEFF +/- 0.55 HOIST BEAMS 4,000 LB LOAD (2,000 LBS / BEAM)


MATERIALS

- 1. ALL STRUCTURAL LUMBER SHALL BE SOUTHERN YELLOW PINE NO. 2 OR BETTER
- 2. ALL LUMBER EXPOSED TO THE WEATHER OR GROUND SHALL BE PRESSURE TREATED.
- ALL PRESSURE TREATED LUMBER IN CONTACT WITH WATER SHALL BE WRAPPED IN PLASTIC OR OTHER APPROVED SYSTEM TO PREVENT LEACHING OF CHEMICALS INTO THE WATER. TELIGA MA
- 4. ALL HURRICANE LOAD CONNECTORS SHALL BE AS NOTED ON PLANS.

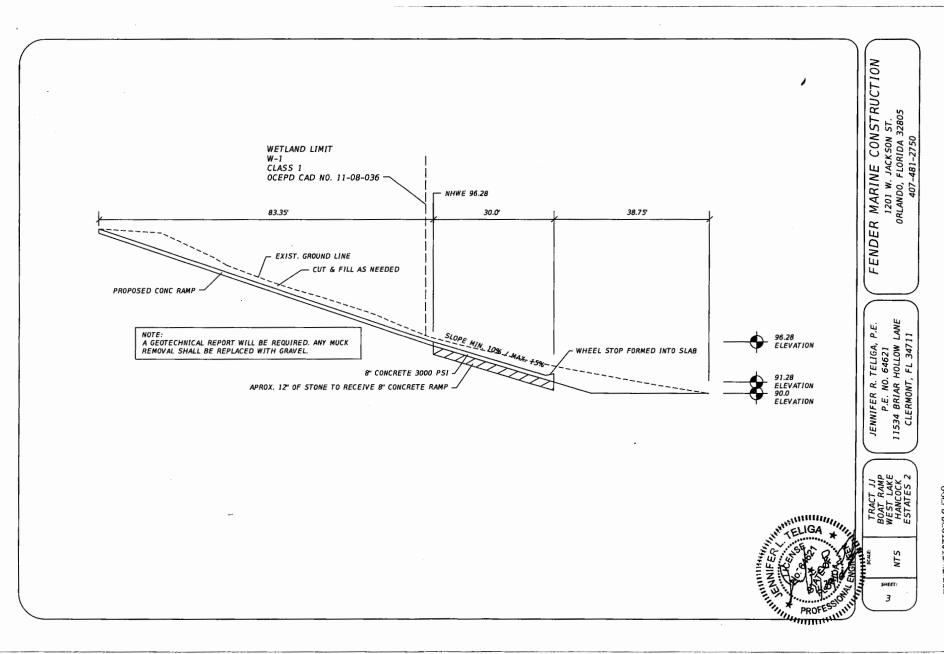

OCEPD DEC12016PM2:252

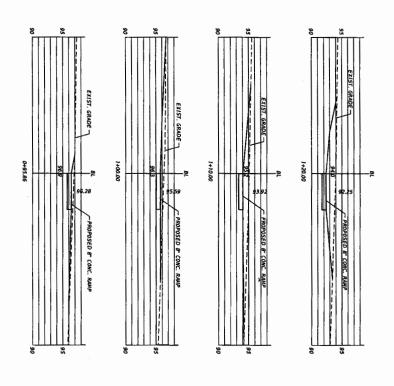


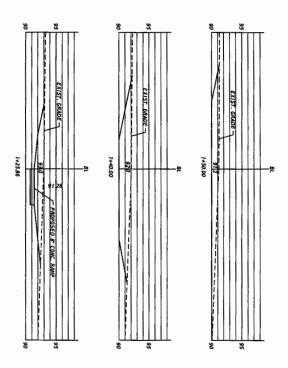






TRACT JJ
BOAT RAKE
WEST LAKE
HANCOCK
ESTATES
PHASE 2


JENNIFER R. TELIGA, P.E. P.E. NO. 64621 11534 BRIAR HOLLOW LANE CLERMONT, FL 34711 FENDER MARINE CONSTRUCTION
1201 W. JACKSON ST.
0RLANDO, FLORIDA 32805
407-481-2750

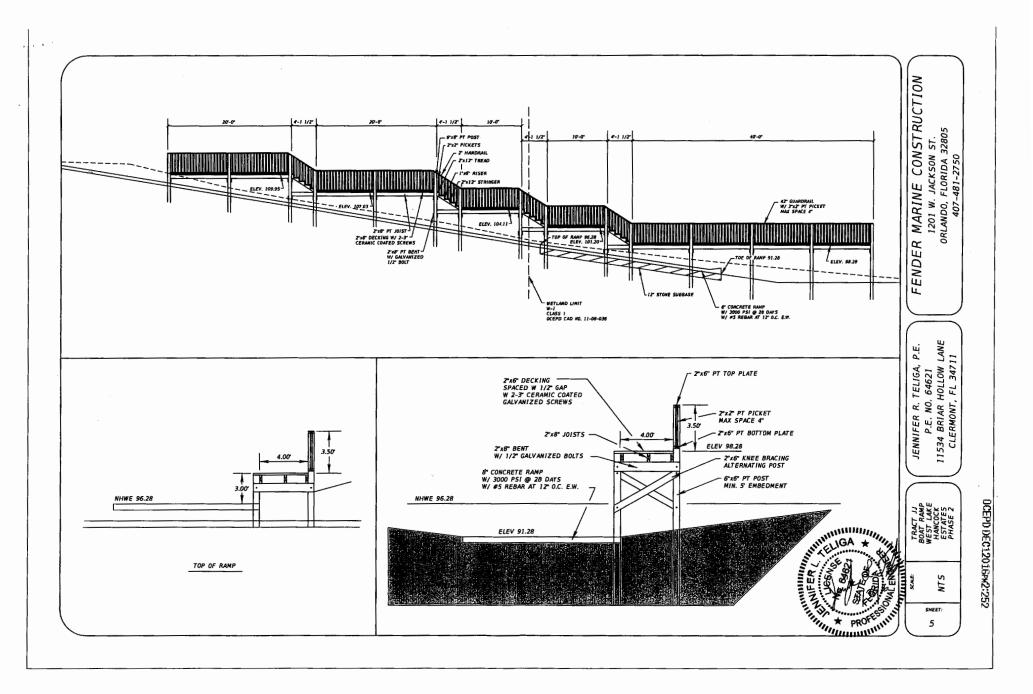

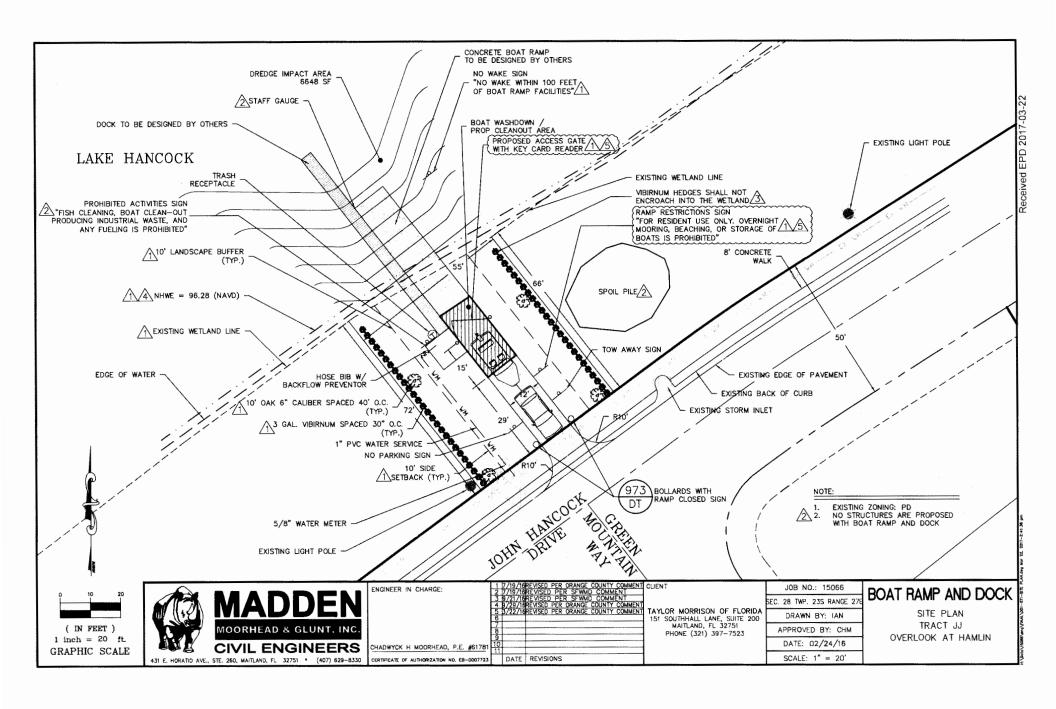

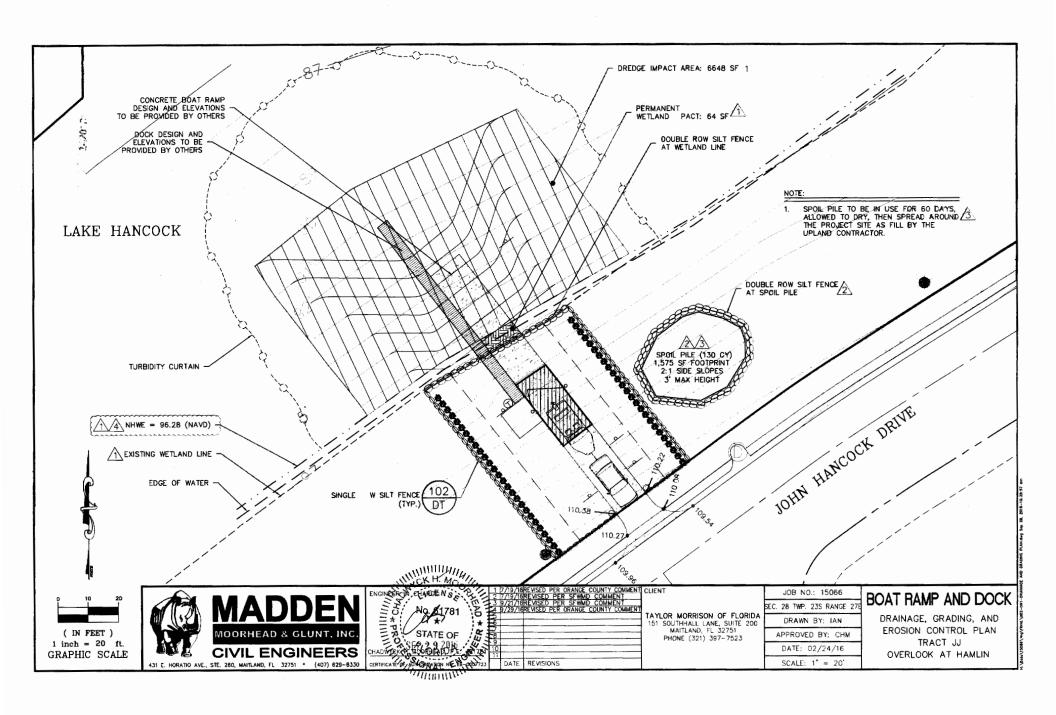

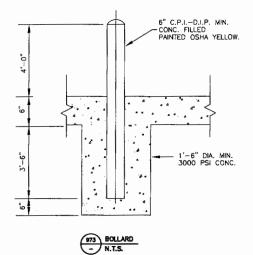

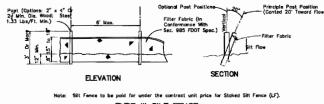

Type III Siit Fence

Note: Spacing for Type III Fence to be in accordance with Chart I, Sheet 1 of 3 and ditch installations at drainage structures Sheet 2 of 3,

TYPE III SILT FENCE






Do not deptay in a monner that silt fences will act as a dam across permanent flowing watercourses. Silt fences are to be used at upland locations and turbidity barriers used at permanent balles of water.

SILT FENCE APPLICATIONS





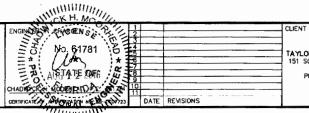

CLIENT	JOB NO.: 15066				
ll .	SEC. 28 TWP. 23S RANGE 27				
TAYLOR MORRISON OF FLORIDA 151 SOUTHHALL LANE, SUITE 200 MAITLAND, FL 32751 PHONE (321) 397-7523	DRAWN BY: IAN				
	APPROVED BY: CHM				
	DATE: 02/24/16				
	SCALE: 1" = 20'				

BOAT RAMP AND DOCK

CONSTRUCTION DETAILS TRACT JJ OVERLOOK AT HAMLIN