ORANGE COUNTY

Interoffice Memorandum

Received: August 20, 2021 @ 8:35 a.m. No Advertising Requirements

August 20, 2021

To:

Katie Smith, Manager

Comptroller Clerk's Office

Through:

Cheryl Gillespie, Agenda Development Supervisor

Agenda Development

From:

David D. Jones, P.E., CEP, Manager

Environmental Protection Division

(407) 836-1406

Staff Person:

Elizabeth R. Johnson, CEP, Assistant Manager

Environmental Protection Division

(407) 836-1511

Subject:

Request for Public Hearing on September 28, 2021 at 2:00 p.m., for a Conservation Area Impact Permit Application (CAI-20-12-075) for impacts to a surface water associated with the construction of a stormwater pond for the Orlando Utilities Commission Substation – Clapp Simms Duda Road Project located at 10708 Clapp Simms Duda Road,

Orlando, FL 32832, Parcel ID No. 32-24-31-0000-00-008, District 4

Applicant:

Orlando Utilities Commission (OUC)

Type of Hearing:

Conservation Area Impact Permit Application

Hearing required by

Florida Statute # or Code:

Orange County Comprehensive Plan

Advertising requirements:

None

Advertising timeframes:

N/A

Abutters to be notified:

The applicant and agent will be notified at least seven days prior to the hearing by the Environmental Protection Division (EPD).

Notification of abutters is not necessary.

Estimated time required

For public hearing:

2 minutes

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August 20, 2021

Request for Public Hearing on September 28, 2021 for Conservation Area Impact Permit Application for OUC Substation – Clapp Simms Duda Road Project (CAI-20-12-075)

Municipality or other Public Agency to be

notified:

South Florida Water Management District,

Lisa Prather, <u>lprather@sfwmd.gov</u>

Hearing Controversial:

No

District #:

4

Materials being submitted as backup for public hearing request:

- 1. Site Plan
- 2. Location Map

Special Instructions to Clerk:


1. Once the Board of County Commissioners makes a decision on the Conservation Area Impact Permit Application, please submit the decision letter to Liz Johnson with EPD. EPD will issue the decision to the applicant.

RB/NT/TMH/ERJ/DJ: jk

Attachments

Conservation Area Impact Permit Request



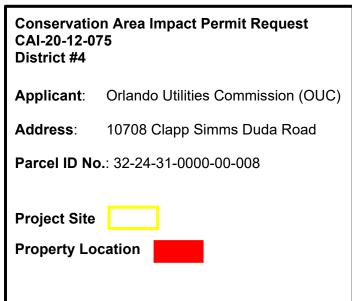





BOUNDARY AND TOPOGRAPHIC SURVEY

SECTION 32, TOWNSHIP 24 SOUTH, RANGE 31 EAST ORANGE COUNTY, FLORIDA

N:1459776.14

E: 581210.38

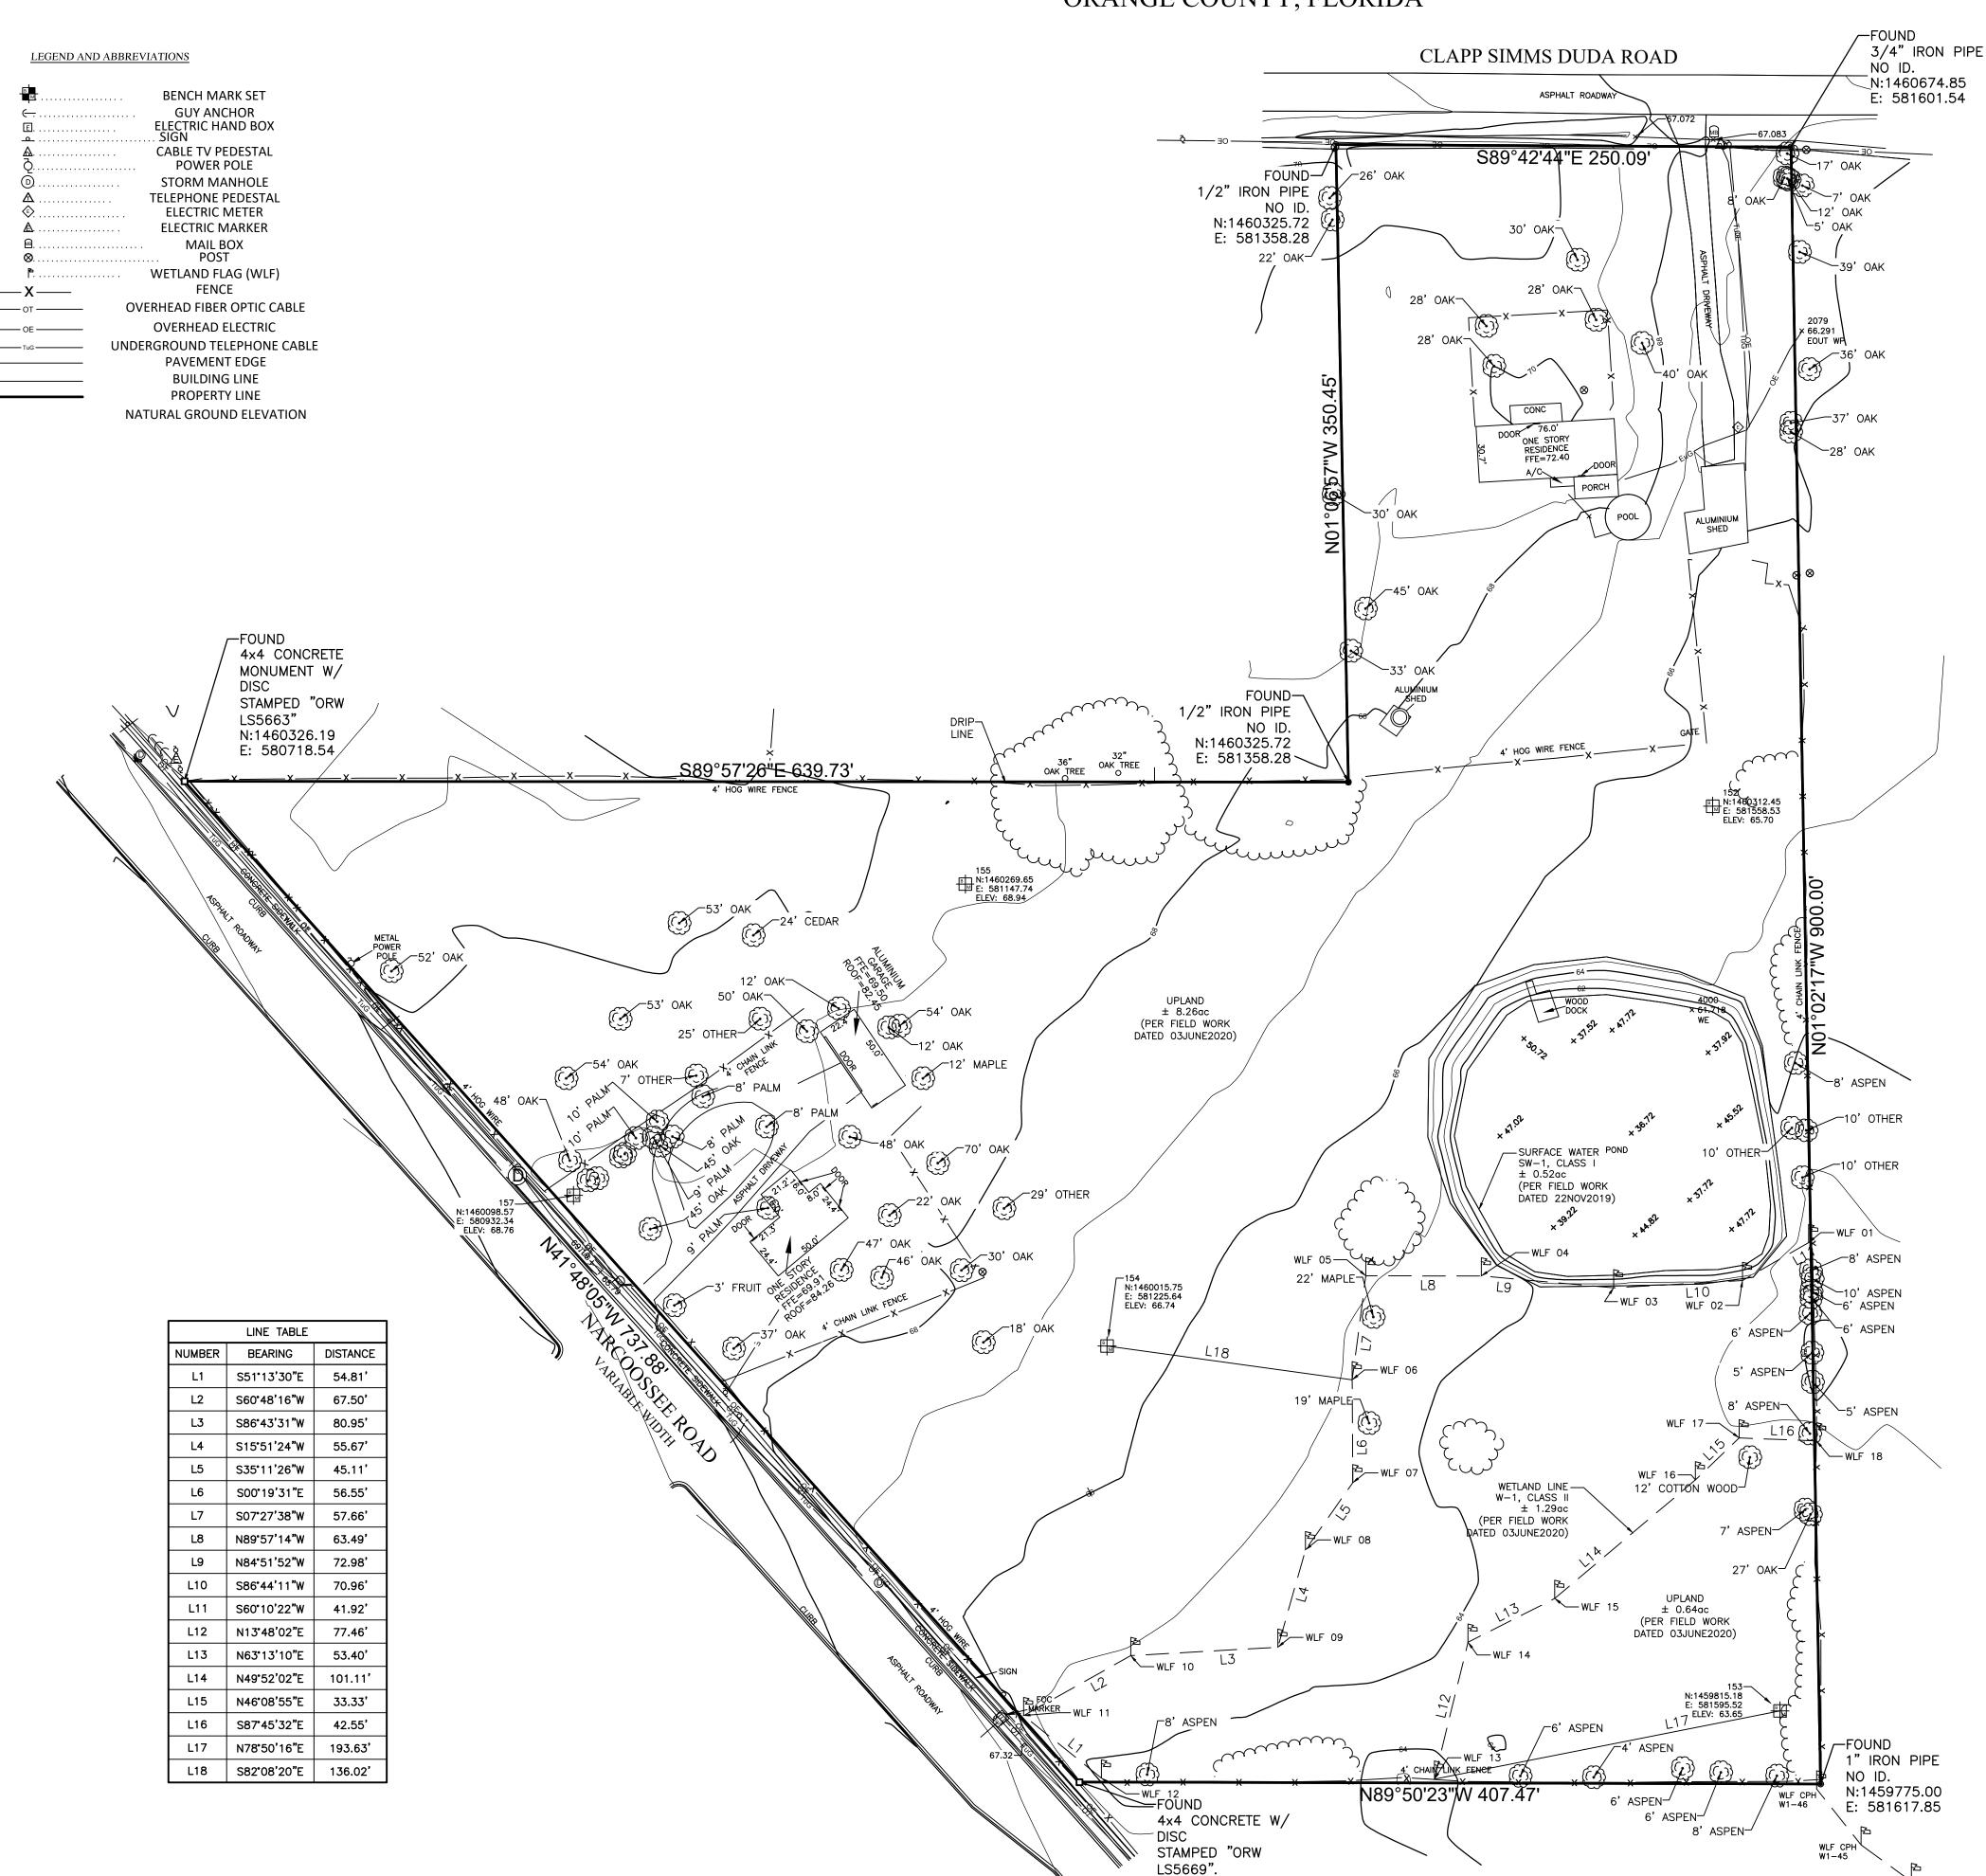

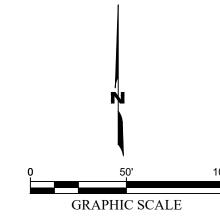

LEGAL DESCRIPTION:
A PARCEL OF LAND AS RECORDED IN ORANGE COUNTY, FLORIDA; INSTRUMENT NUMBER 20190300699

FROM THE SE CORNER OF THE SW 1/4 OF THE SE 1/4 OF SECTION 32, TOWNSHIP 24 SOUTH, RANGE 31 EAST, RUN NORTH 430 FEET TO THE POINT OF BEGINNING: RUN THENCE NORTH 900 FEET. THENCE WEST 250 FEET THENCE SOUTH 350 FEET THENCE WEST 640.70 FEET TO STAKE ON EAST LINE OF NARCOOSSEE—CONWAY ROAD, THENCE SOUTHEASTERLY ALONG EAST LINE OF SAID HIGHWAY 738.5 FEET TO STAKE DUE WEST OF POINT OF BEGINNING, THENCE DUE EAST 409.7 TO POINT OF

- SURVEYOR'S NOTES: SUBJECT TO RIGHT-OF-WAY DEED TO ORANGE COUNTY AS RECORDED IN DEED BOOK 558, PAGE 541, ORANGE RECORDS. 1. EASEMENTS OR RIGHTS OF WAY THAT APPEAR ON RECORDED PLANS OR THAT HAVE BEEN FURNISHED TO THE SURVEYOR BY OTHERS HAVE BEEN INCORPORATED INTO THIS DRAWING WITH APPROPRIATE NOTATION. OTHER EASEMENTS MAY BE DISCOVERED BY A SEARCH OF THE PUBLIC RECORDS.
- 2. VERTICAL INFORMATION SHOWN HEREON ARE BASED ON A CLOSED LEVEL LOOP RUN FROM ORANGE COUNTY PID#S1601010, BEING A ORANGE COUNTY ALUMINIUM DISC STAMPED "S-1601-010", HAVING AN ELEVATION OF 66.708 FEET TO ORANGE COUNTY PID#S1601009 BEING A ORANGE COUNTY ALUMINIUM DISC STAMPED "S-1601-009" NAVD88 DATUM.
- 3. HORIZONTAL POSITIONS FOR ALL FEATURES SHOWN ON THE MAP ARE RELATIVE TO (NORTH AMERICAN DATUM, NAD83, 2011 ADJUSTMENT, FLORIDA STATE PLANE COORDINATE SYSTEM, FLORIDA EAST ZONE) AND ARE BASED ON FLORIDA DEPARTMENT OF TRANSPORTATION'S "FLORIDA PERMANENT REFERENCE NETWORK" GPS CONTINUOUSLY OPERATING REFERENCE STATIONS "INGS", DISTANCES SHOWN ARE GRID DISTANCES.
- 4. MINIMUM HORIZONTAL ACCURACY FOR THIS SURVEY IS IN ACCORDANCE WITH THE STANDARDS OF PRACTICE SET FORTH BY THE BOARD OF PROFESSIONAL SURVEYORS AND MAPPERS IN CHAPTER 5J-17 REQUIREMENTS OF FLORIDA ADMINISTRATION CODE. THE MAP AND MEASUREMENT METHODS USED FOR THIS SURVEY MEET OR EXCEED THIS REQUIREMENT. THE DIMENSIONS SHOWN HEREON ARE IN UNITED STATES STANDARD SURVEY FEET AND DECIMALS THEREOF.
- 5. THIS SURVEY WAS PERFORMED WITHOUT BENEFIT OF AN ABSTRACT, TITLE SEARCH, TITLE OPINION OR TITLE COMMITMENT. A TITLE SEARCH MAY REVEAL ADDITIONAL INFORMATION AFFECTING THE PARCEL AS SHOWN.
- 6. ADDITIONS OR DELETIONS TO SURVEY MAPS OR REPORTS BY OTHER THAN THE SIGNING PARTY OR PARTIES IS PROHIBITED WITHOUT WRITTEN CONSENT OF THE SIGNING PARTY OR PARTIES.
- 7. INFORMATION SHOWN ON ADJACENT PROPERTIES WAS COMPILED USING LATEST AVAILABLE DATA. NO ATTEMPT WAS MADE BY
- 8. THIS SURVEY IS NOT VALID WITHOUT THE SIGNATURE AND RAISED SEAL OF A FLORIDA LICENSED SURVEYOR AND MAPPER.
- 9. FEATURES SHOWN BY SYMBOL AS INDICATED IN THE LEGEND ARE NOT TO SCALE.
- 10. DIMENSIONS ARE SHOWN IN U.S. SURVEY FEET AND DECIMALS THEREOF.
- 11. COORDINATES ARE BASED ON FIELD SURVEYS USING REAL TIME NETWORK (RTN GPS) (VRS NOW).
- 12. THE SUBJECT PROPERTY HAS PUBLIC ACCESS.
- 13. NO OBSERVED EVIDENCE OR EARTH MOVING WORK, BUILDING CONSTRUCTION, OR BUILDING ADDITIONS WAS MADE BY THIS
- 14. NO OBSERVED EVIDENCE OF SITE BEING USED AS A SOLID WASTE DUMP, SUMP OR SANITARY LANDFILL WAS MADE BY THIS FIRM AT THE TIME OF THIS SURVEY.
- 15. RIGHT OF WAY INFORMATION SHOWN HEREON WAS DETERMINED BY FOUND MONUMENTATION, RECORDED PLATS, RECORDED RIGHT OF WAY MAPS, AND INFORMATION OBTAINED ON THE ORANGE COUNTY PROPERTY APPRAISERS WEB SITE.
- 16. BEARINGS SHOWN HEREON ARE BASED ON GRID.
- 17. THE COMBINED GRID SCALE FACTOR AT THIS LOCATION IS 0.9999488164. THIS DRAWING IS IN GRID. ALL DIMENSIONS SHOULD BE MULTIPLIED BY 1.000051186 TO OBTAIN GROUND DISTANCES.
- 18. WETLAND FLAGS INITIALLY LOCATED ON 11/22/2019 AND ADDED HEREIN ON 11/25/2019.
- 19. WETLAND FLAGS RE-LOCATED IN THE FIELD ON 06/03/2020 AND SURVEY UPDATED 06/09/2020.
- 20. WETLAND, SURFACE WATER AND UPLAND LABELS ADDED TO UPDATED SURVEY 29 SEPT 2020.
- 21. WETLAND LABELS UPDATED AND LABELS ADDED TO DELINIATED WETLAND LINES 18 NOV 2020.

SURVEYOR'S CERTIFICATE

I HEREBY CERTIFY THIS SURVEY MEETS THE APPLICABLE "STANDARDS OF PRACTICE" AS SET FORTH BY THE FLORIDA BOARD OF PROFESSIONAL SURVEYORS AND MAPPERS IN RULE 5J17.050-.052 FLORIDA ADMINISTRATIVE CODE.

JASON D. HILL PROFESSIONAL SURVEYOR AND MAPPER FLORIDA REGISTRATION NUMBER 6008 SURVEYING AND MAPPING, LLC.

NOT VALID WITHOUT THE SIGNATURE AND THE ORIGINAL RAISED SEAL OF A FLORIDA LICENSED SURVEYOR AND MAPPER.

Split Oak Substation

Orange County, FL

LEGAL DESCRIPTION:

FROM THE SE CORNER OF THE SW 1/4 OF THE SE 1/4 OF SECTION 32, TOWNSHIP 24 SOUTH, RANGE 31 EAST, RUN NORTH 430 FEET TO THE POINT OF BEGINNING; RUN THENCE NORTH 900 FEET, THENCE WEST 250 FEET THENCE SOUTH 350 FEET THENCE WEST 640.70 FEET TO STAKE ON EAST LINE OF NARCOOSSEE—CONWAY ROAD, THENCE SOUTHEASTERLY ALONG EAST LINE OF SAID HIGHWAY 738.5 FEET TO STAKE DUE WEST OF POINT OF BEGINNING, THENCE DUE EAST 409.7 TO POINT OF BEGINNING.


SUBJECT TO RIGHT-OF-WAY DEED TO ORANGE COUNTY AS RECORDED IN DEED BOOK 558, PAGE 541, ORANGE RECORDS.

Parcel Id. No.: 32-24-31-0000-00-008

10708 Clapp Simms Duda Road Orlando, FL 32832



Owner/Developer/Applicant: OUC 100 W. Anderson St. Orlando, FL 32801

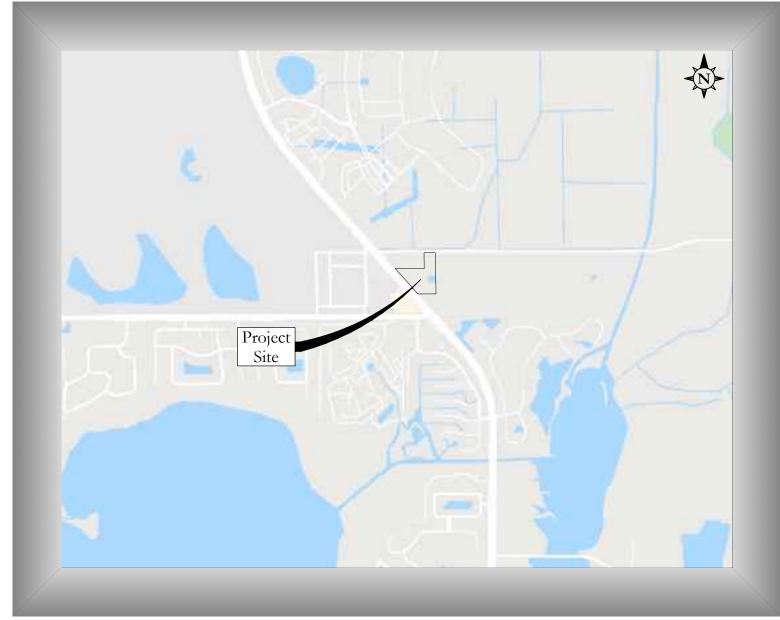

Sheet Index Subm./Rev. Sheet Id. **Sheet Title** 1 2 3 4 5 Cover Sheet C0.00General Notes C0.01C0.02General Notes Site Plan C1.00. . . . OCFRD Vehicle Turning Movement Plan & C1.10 Needed Fire Flow Calculation C2.00Erosion Control And Demolition Plan Geometry Plan C3.00Grading & Drainage Plan C4.00 **Grading Sections** C4.10 **Grading Sections** C4.20 C4.30 Structure Details Utility Plan C5.00

Construction Details

Construction Details

Landscape & Irrigation Plans

C6.00

L-1	Tree Removal Plan	•	•	•
L-2	Landscape Plan	•		
L-3	Littoral Shelf Details			
3 L-4	Irrigation Plan	I	■	•

Survey Plans

Boundary And Topographic Survey

	<u>Date</u>	Description
	2/14/2020	Orange County Submittal
	2/28/2020	FDEP ERP Submittal
1	4/17/2020	Orange County Comments
2	12/17/2020	Orange County Comments
3	7/14/2021	Orange County EPD Comments



POULOS BENNETT

NOTE:
CONSTRUCTION PLANS WERE PREPARED IN ACCORDANCE WITH THE LATEST MANUAL OF UNIFORM STANDARDS FOR DESIGN, CONSTRUCTION, AND MAINTENANCE FOR STREETS AND HIGHWAYS, FDOT GREEN BOOK, AND ORANGE COUNTY REGULATIONS

Civil Engineer: Poulos & Bennett, LLC

2602 E. Livingston St. Orlando, FL 32803 407.487.2594


Surveying and Mapping, LLC 8529 Southpark Circle Orlando, FL 32819 407.484.9345

Geotechnical Engineer: Ardaman & Associates, Inc. 8008 S. Orange Ave Orlando, FL 32809 407.855.3860

Landscape Architect:

Schweizer Bojack Landscape Architecture LLC P.O. Box 948383 Maitland, FL 32794 407-376-1423

Vicinity Map
Scale: 1" = 2,000'

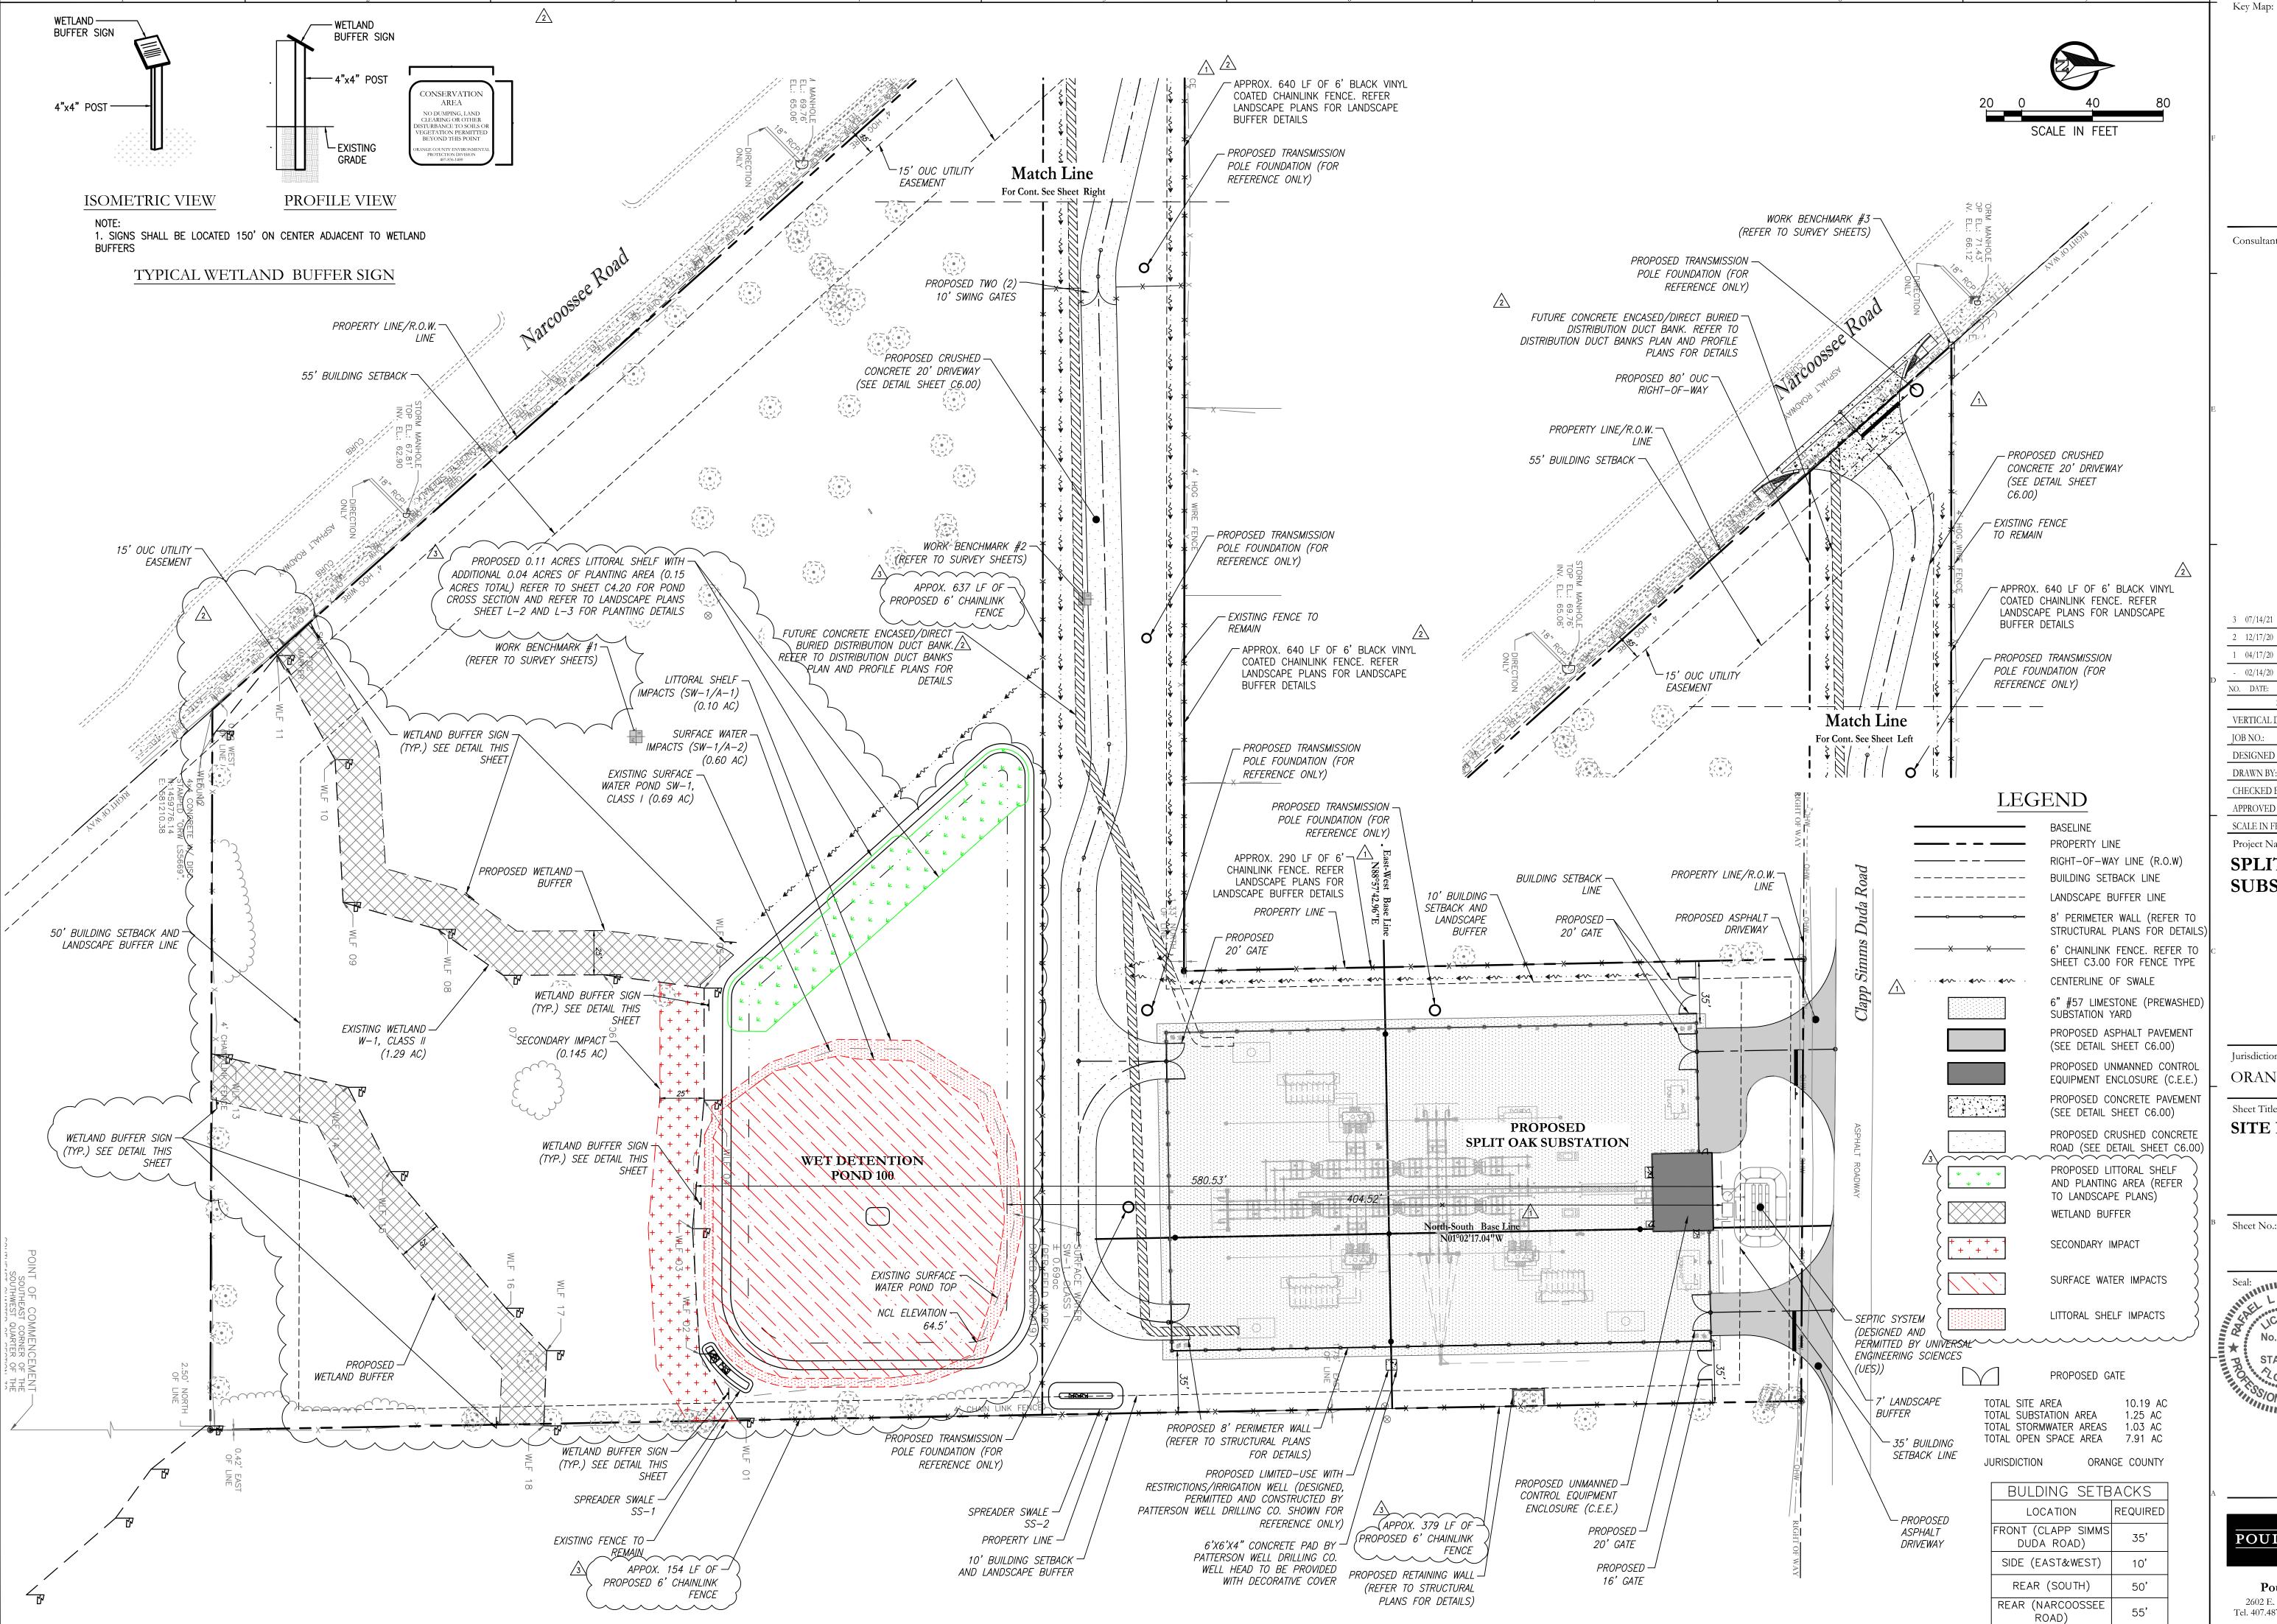

Consultant:

3 07/14/21 ORANGE COUNTY EPD COMMENTS

2 12/17/20 ORANGE COUNTY COMMENTS 1 04/17/20 ORANGE COUNTY COMMENTS - 02/14/20 ORANGE COUNTY & FDEP ERP SUBMITTA

NO. DATE: DESCRIPTIONS: SUBMISSIONS/REVISIONS NAVD 88 VERTICAL DATUM: JOB NO.: 19-063

DESIGNED BY RA RA DRAWN BY: RO CHECKED BY: JTP APPROVED BY SCALE IN FEET: 1'' = 40'

Project Name:

SPLIT OAK SUBSTATION

Jurisdiction:


ORANGE COUNTY, FL

Sheet Title:

SITE PLAN


Sheet No.:

C1.00

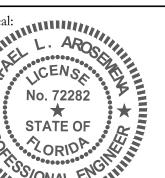


POULOS BENNETT


Poulos & Bennett, LLC 2602 E. Livingston St., Orlando, FL 32803 Tel. 407.487.2594 www.poulosandbennett.com Eng. Bus. No. 28567

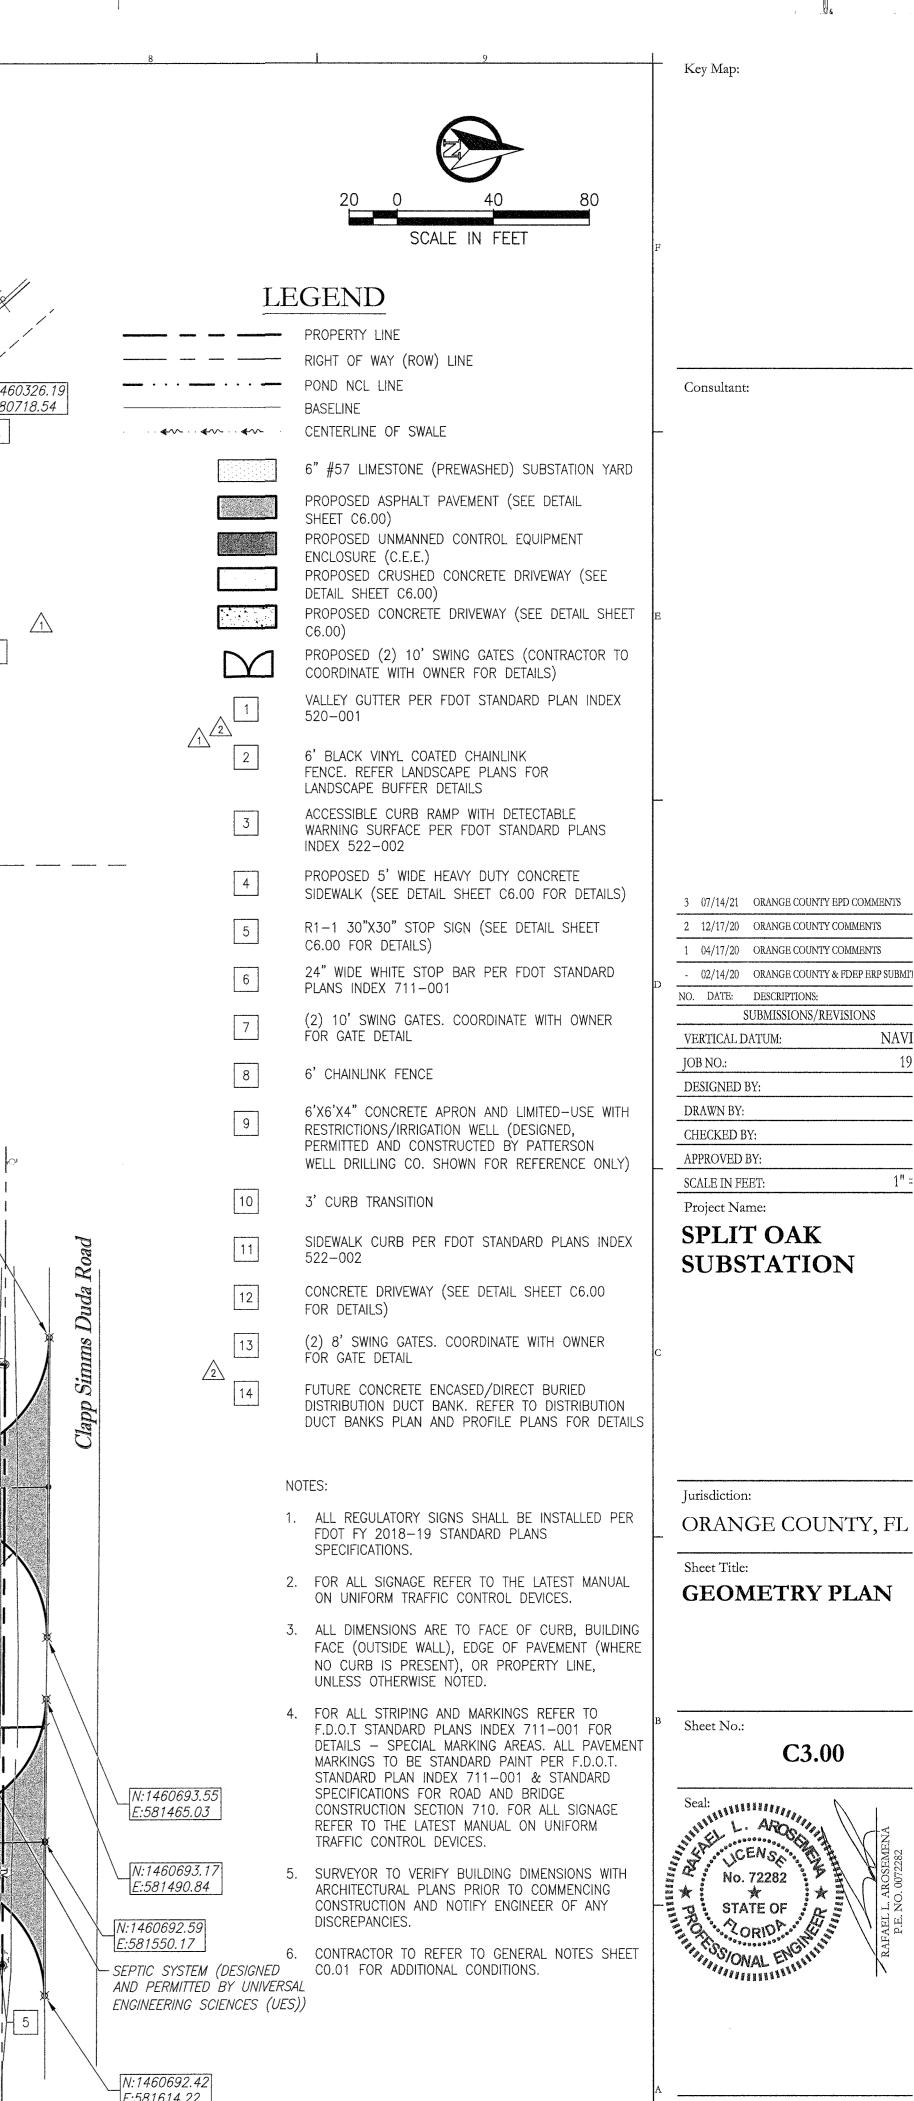

N:1460314.15 E:580711.01 Match Line For Cont. See Sheet Right E:580718.54 N:1460246.00 E:580972.34 N:1460326.01 E:580970.37 N:1460215.39 E:580799.02 17-14:01 8)(» \ 17.5% N48°21'53.26"E 1121 N:1460269.65 17.5% E:581147.74 1751 Match Line For Cont. See Sheet Left N:1460245.84 0 E:581192.83 8 N:1460015.75 *E:581225.64* _S72°10'46.77"E EXISTING SURFACE -WATER POND SW-1, CLASS 1 (0.69 AC) N:1460694.53 PROPOSED WETLAND -N:1460615.04 E:581340.25 BUFFER E:581352.64 N:1460325.72 E:581358.28 en. en. en. en. en. en. en. en. en. . en/.en..en..en..en EXISTING WETLAND -W−1, CLASS II (1.29 AC) 168.36 PROPOSED N:1460441.69 E:581506.88 SPLIT OAK SUBSTATION WET DETENTION **POND 100** North-South Base Line N01°02'17.04"W L=67.012 R=42.500 PROPOSED WETLAND -14 BUFFER __97.38² E:581579.73\ + + HEEDSTELL JUDIT-E:581594.91 N:1460624.61 8 N:1460204,2 N:1460091.94 E:581602.45 E:581583.27 E:581612.10 N:1460511.66 E:581603.71 E:581614.22 APPROXIMATELY 37 LF OF -RETAINING WALL (REFER TO SPREADER SWALE SS-1 (SEE STRUCTURAL PLANS FOR SPREADER SWALE SS-2 (SEE SHEET C4.20 FOR DETAILS) POULOS BENNET DETAILS SHEET C4.20 FOR DETAILS)

Poulos & Bennett, LLC 2602 E. Livingston St., Orlando, FL 3280 Tel. 407.487.2594 www.poulosandbennett Eng. Bus. Ño. 28567

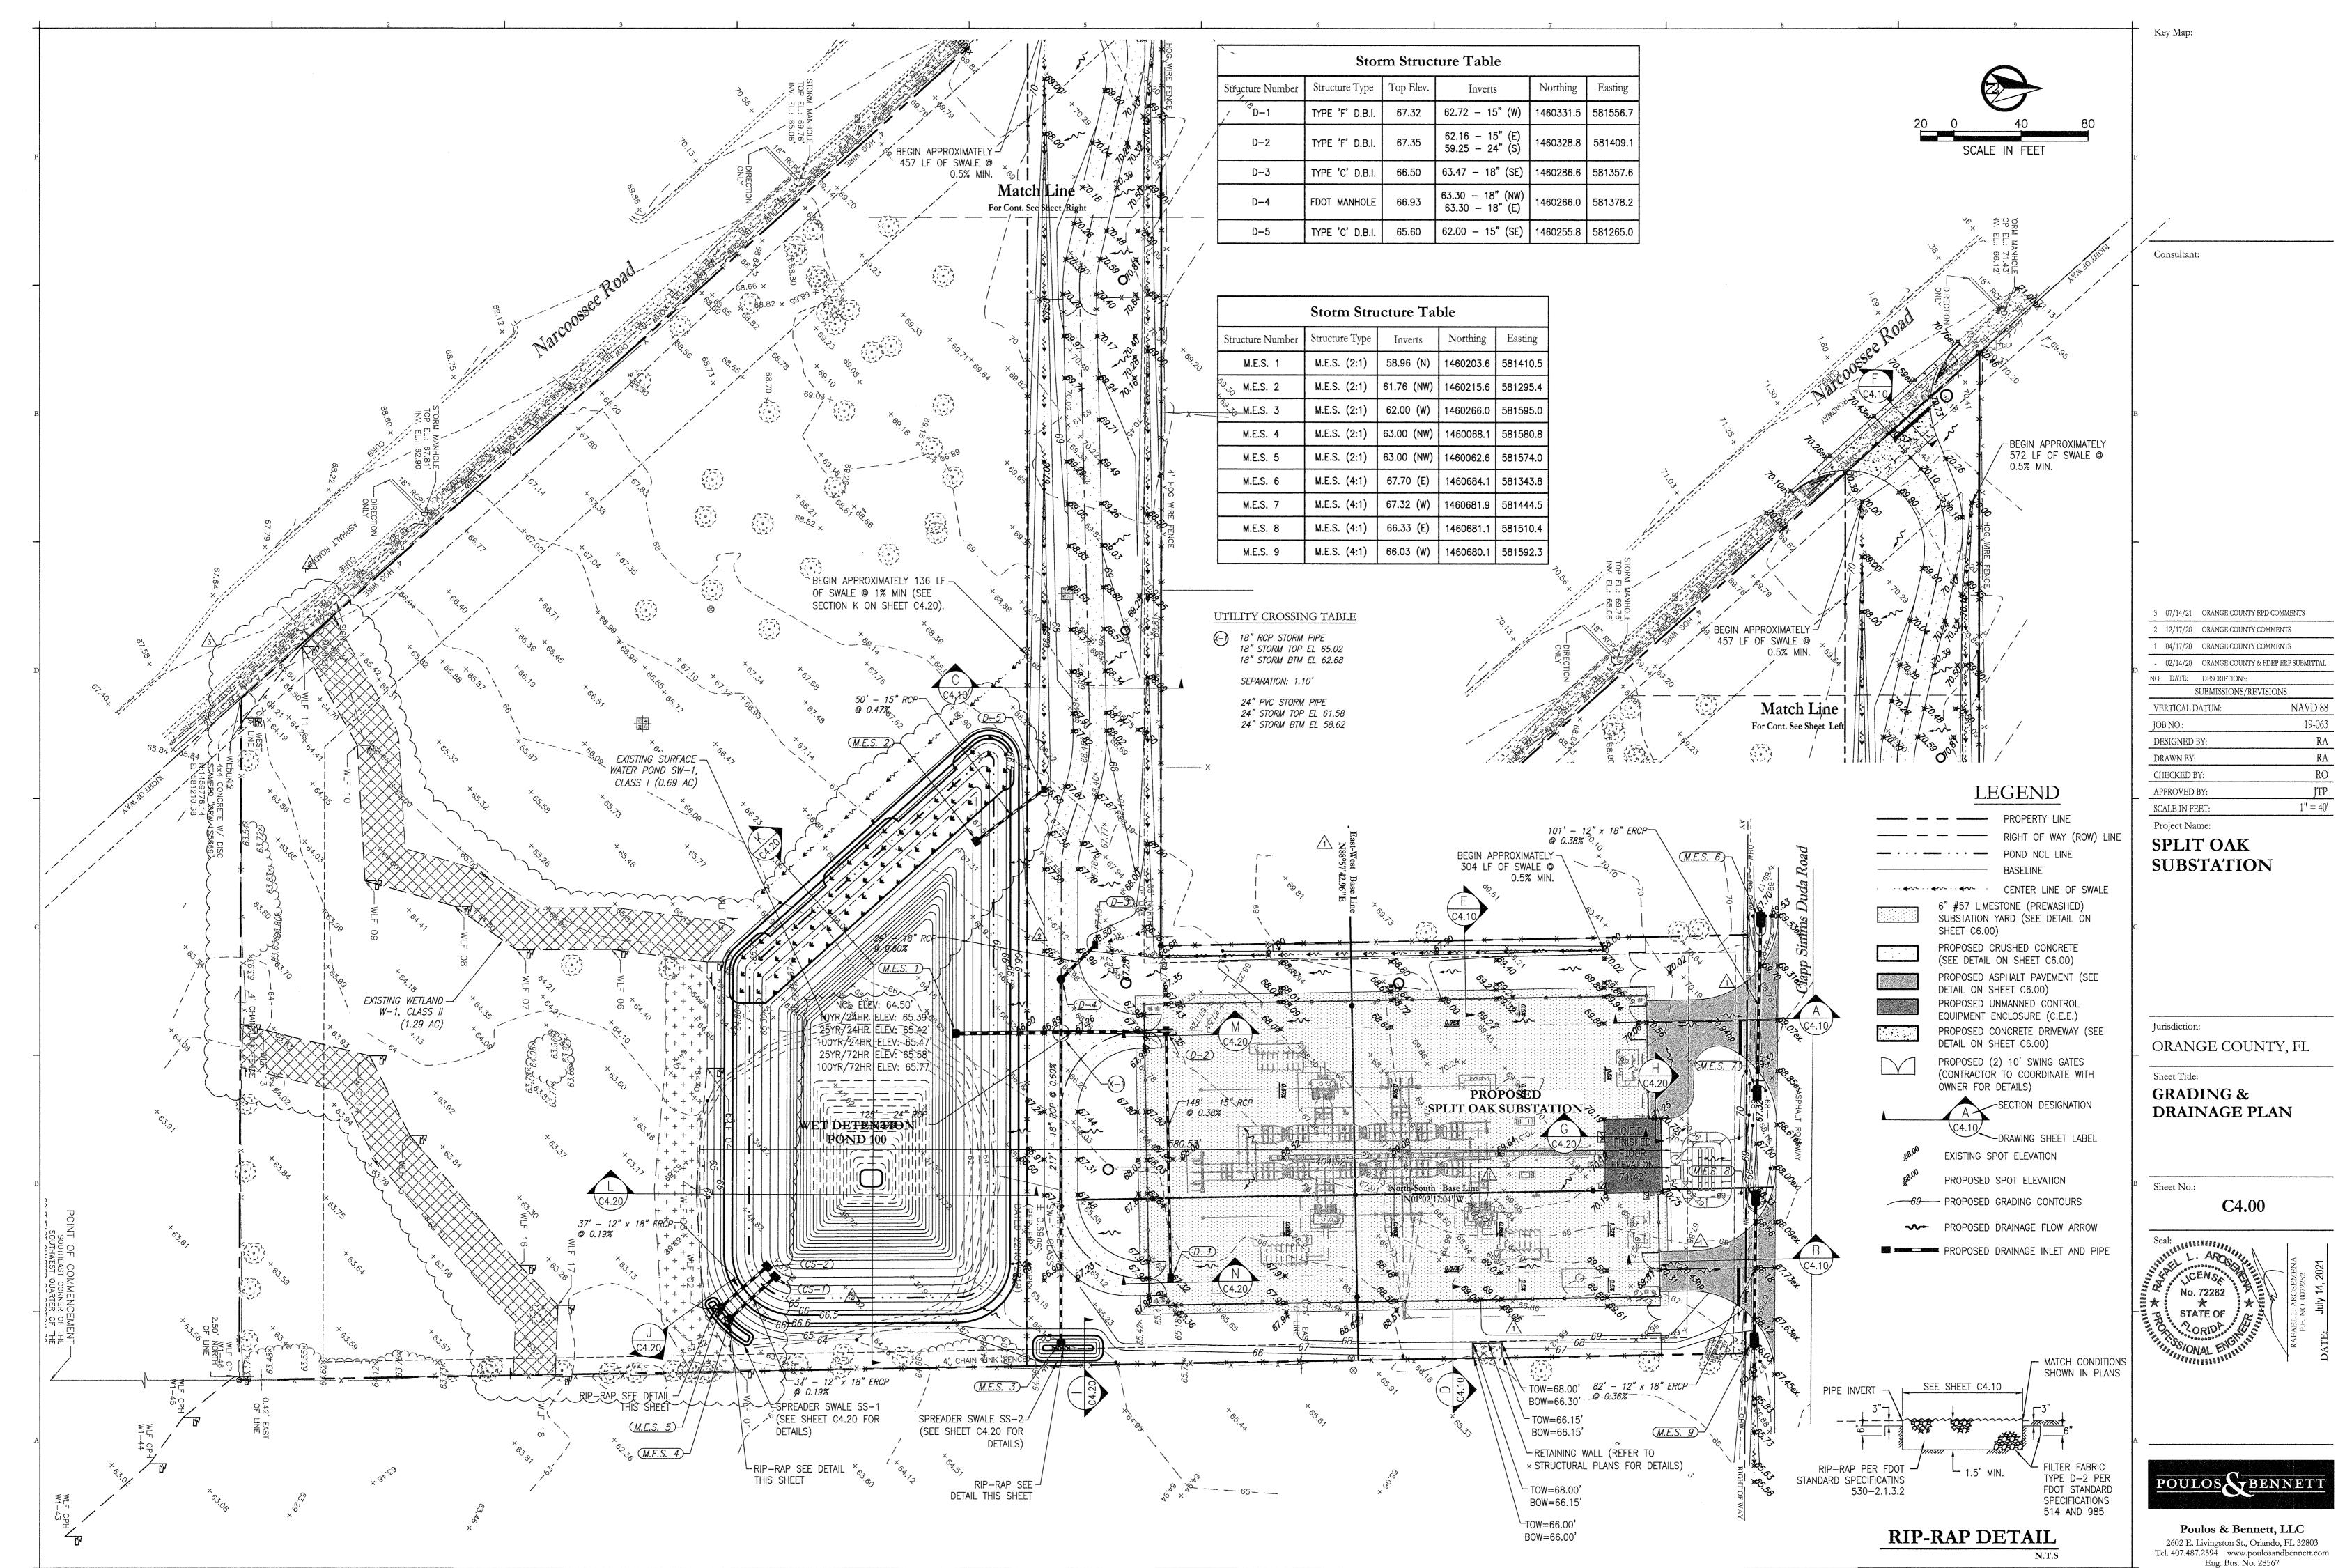

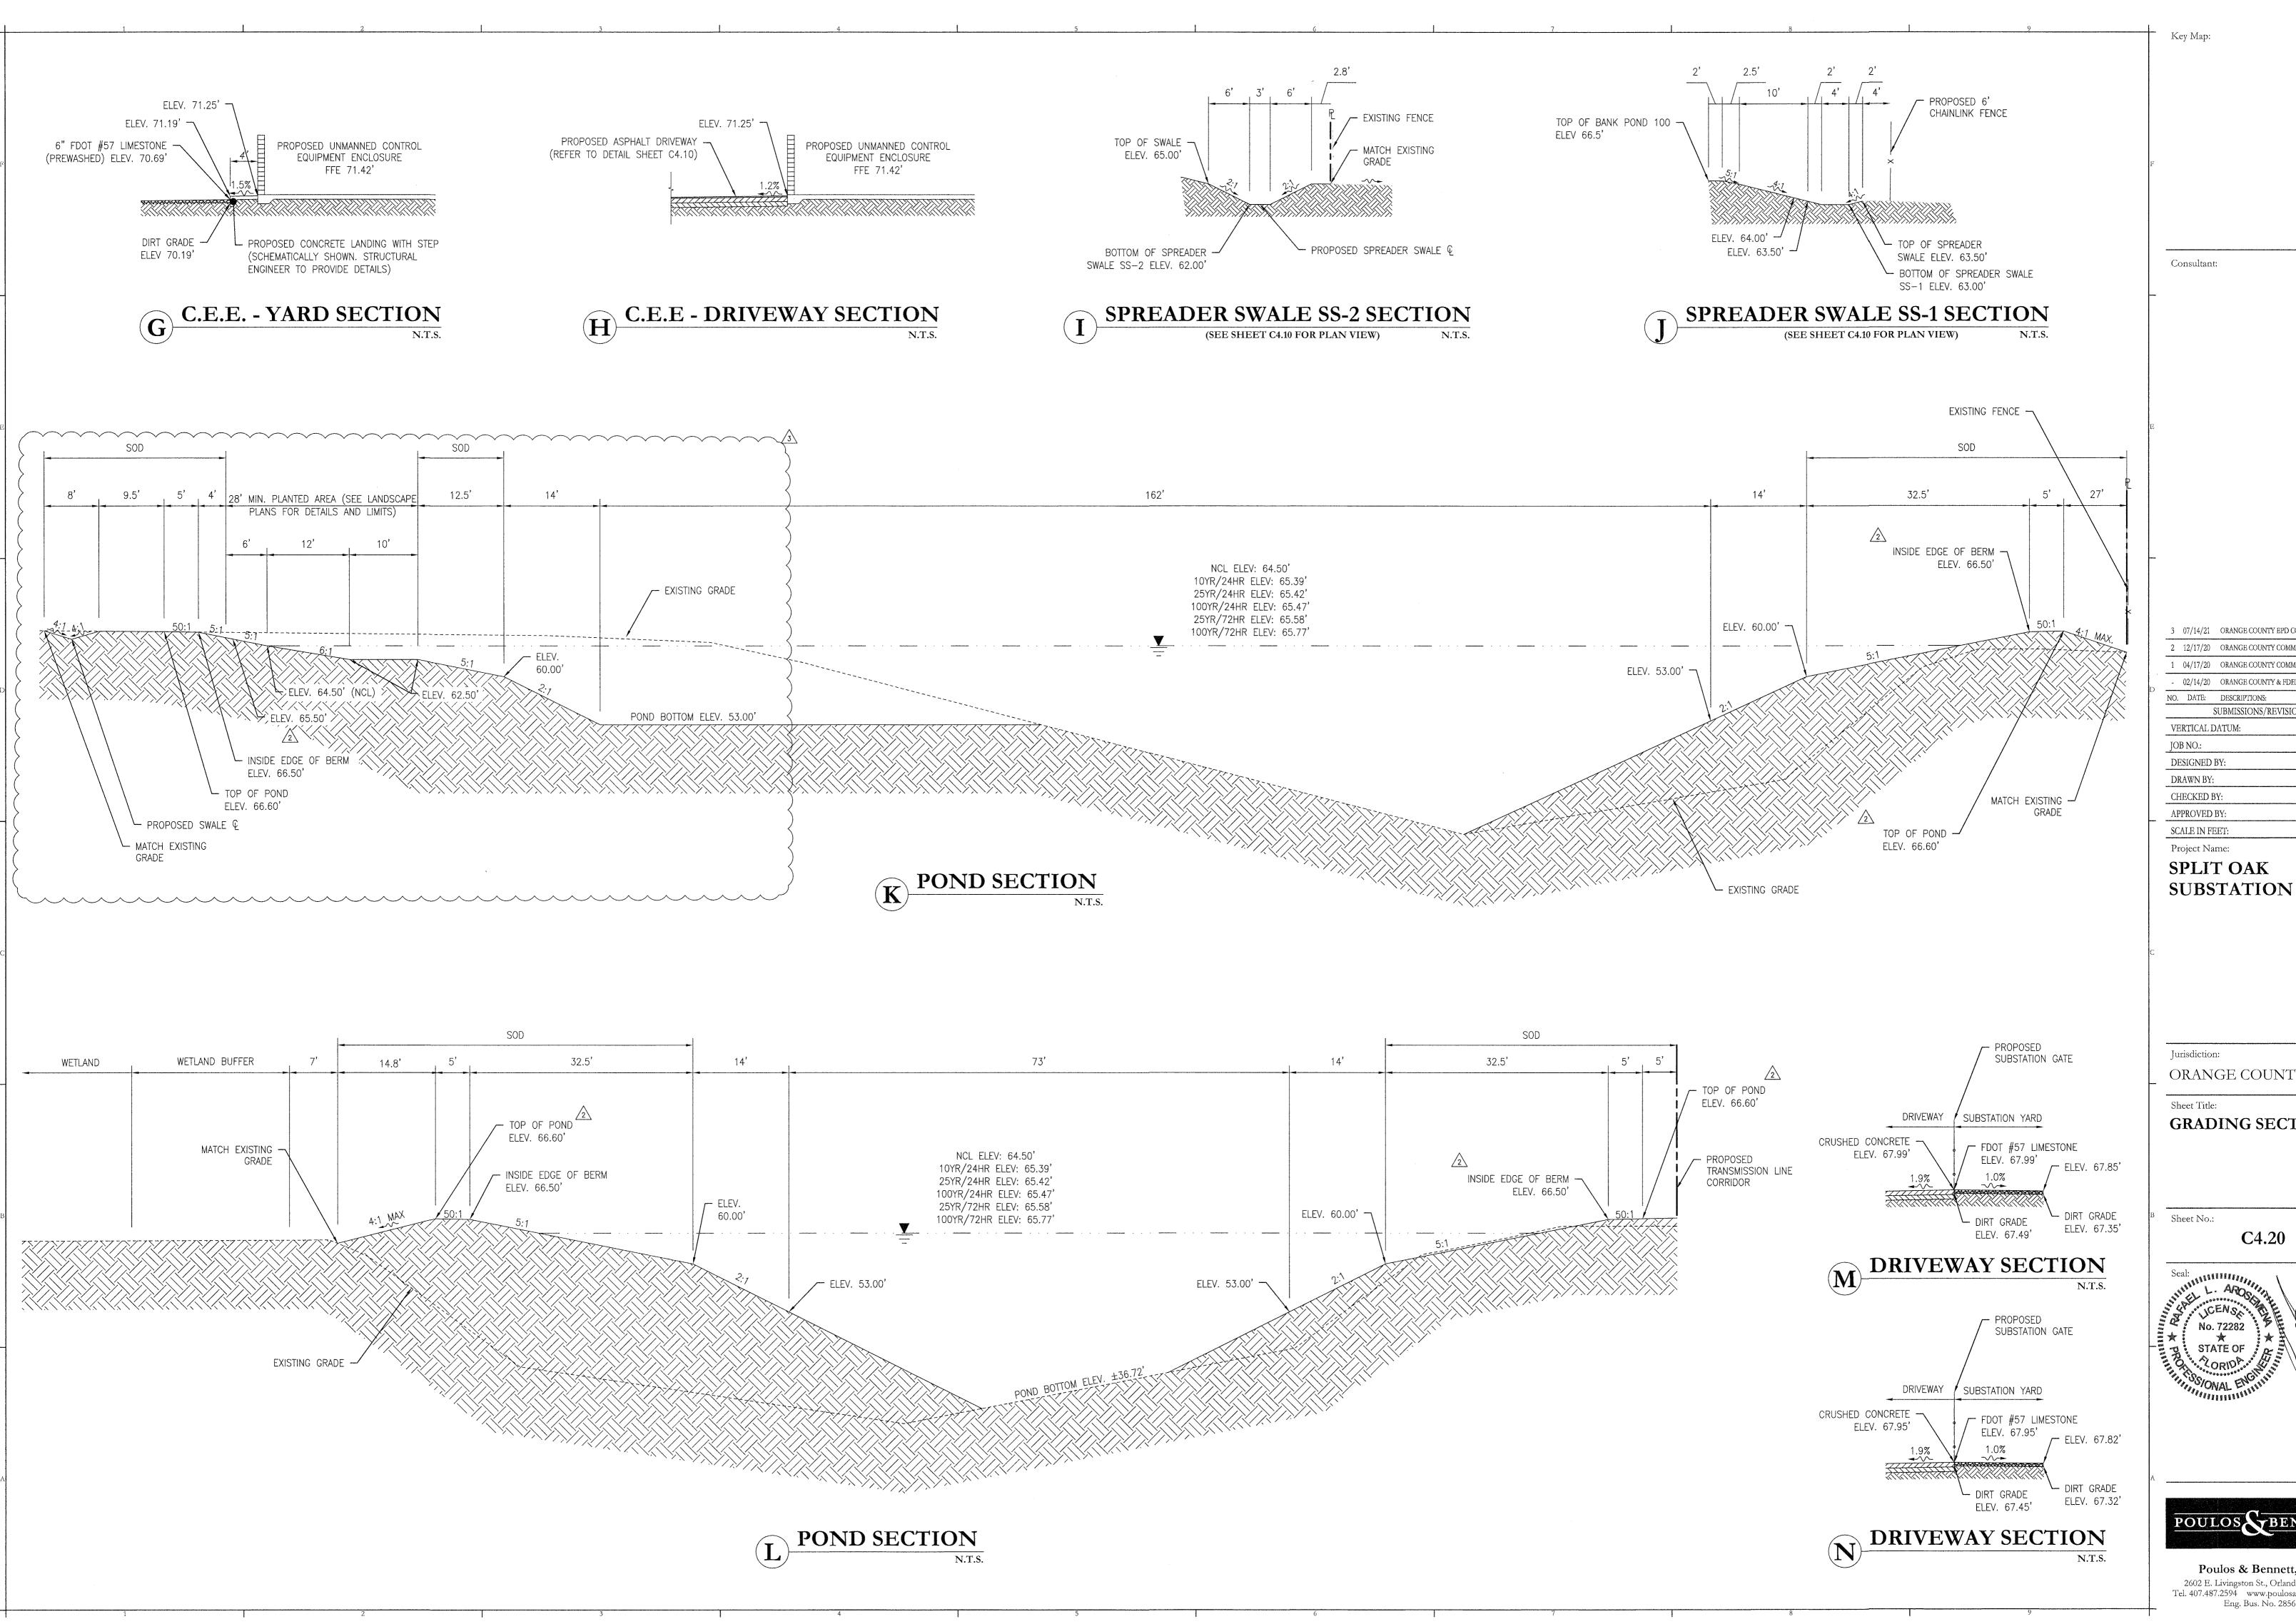

3 07/14/21 ORANGE COUNTY EPD COMMENTS 2 12/17/20 ORANGE COUNTY COMMENTS 1 04/17/20 ORANGE COUNTY COMMENTS - 02/14/20 ORANGE COUNTY & FDEP ERP SUBM NO. DATE: DESCRIPTIONS: SUBMISSIONS/REVISIONS

ORANGE COUNTY, FL

GRADING SECTION

C4.20

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SIDE & REAR PROPERTY LINES)

ZONE 'B' TREE PRESERVATION & REMOVAL: (PROTECTED TREES 10" DBH & ABOVE REQUIRE REPLACEMENT)


> SCHWEIZER BOJACK LANDSCAPE

ARCHITECTURE

/3\ 7/14/21

12/17/20


2/12/20 SHEET NUMBER

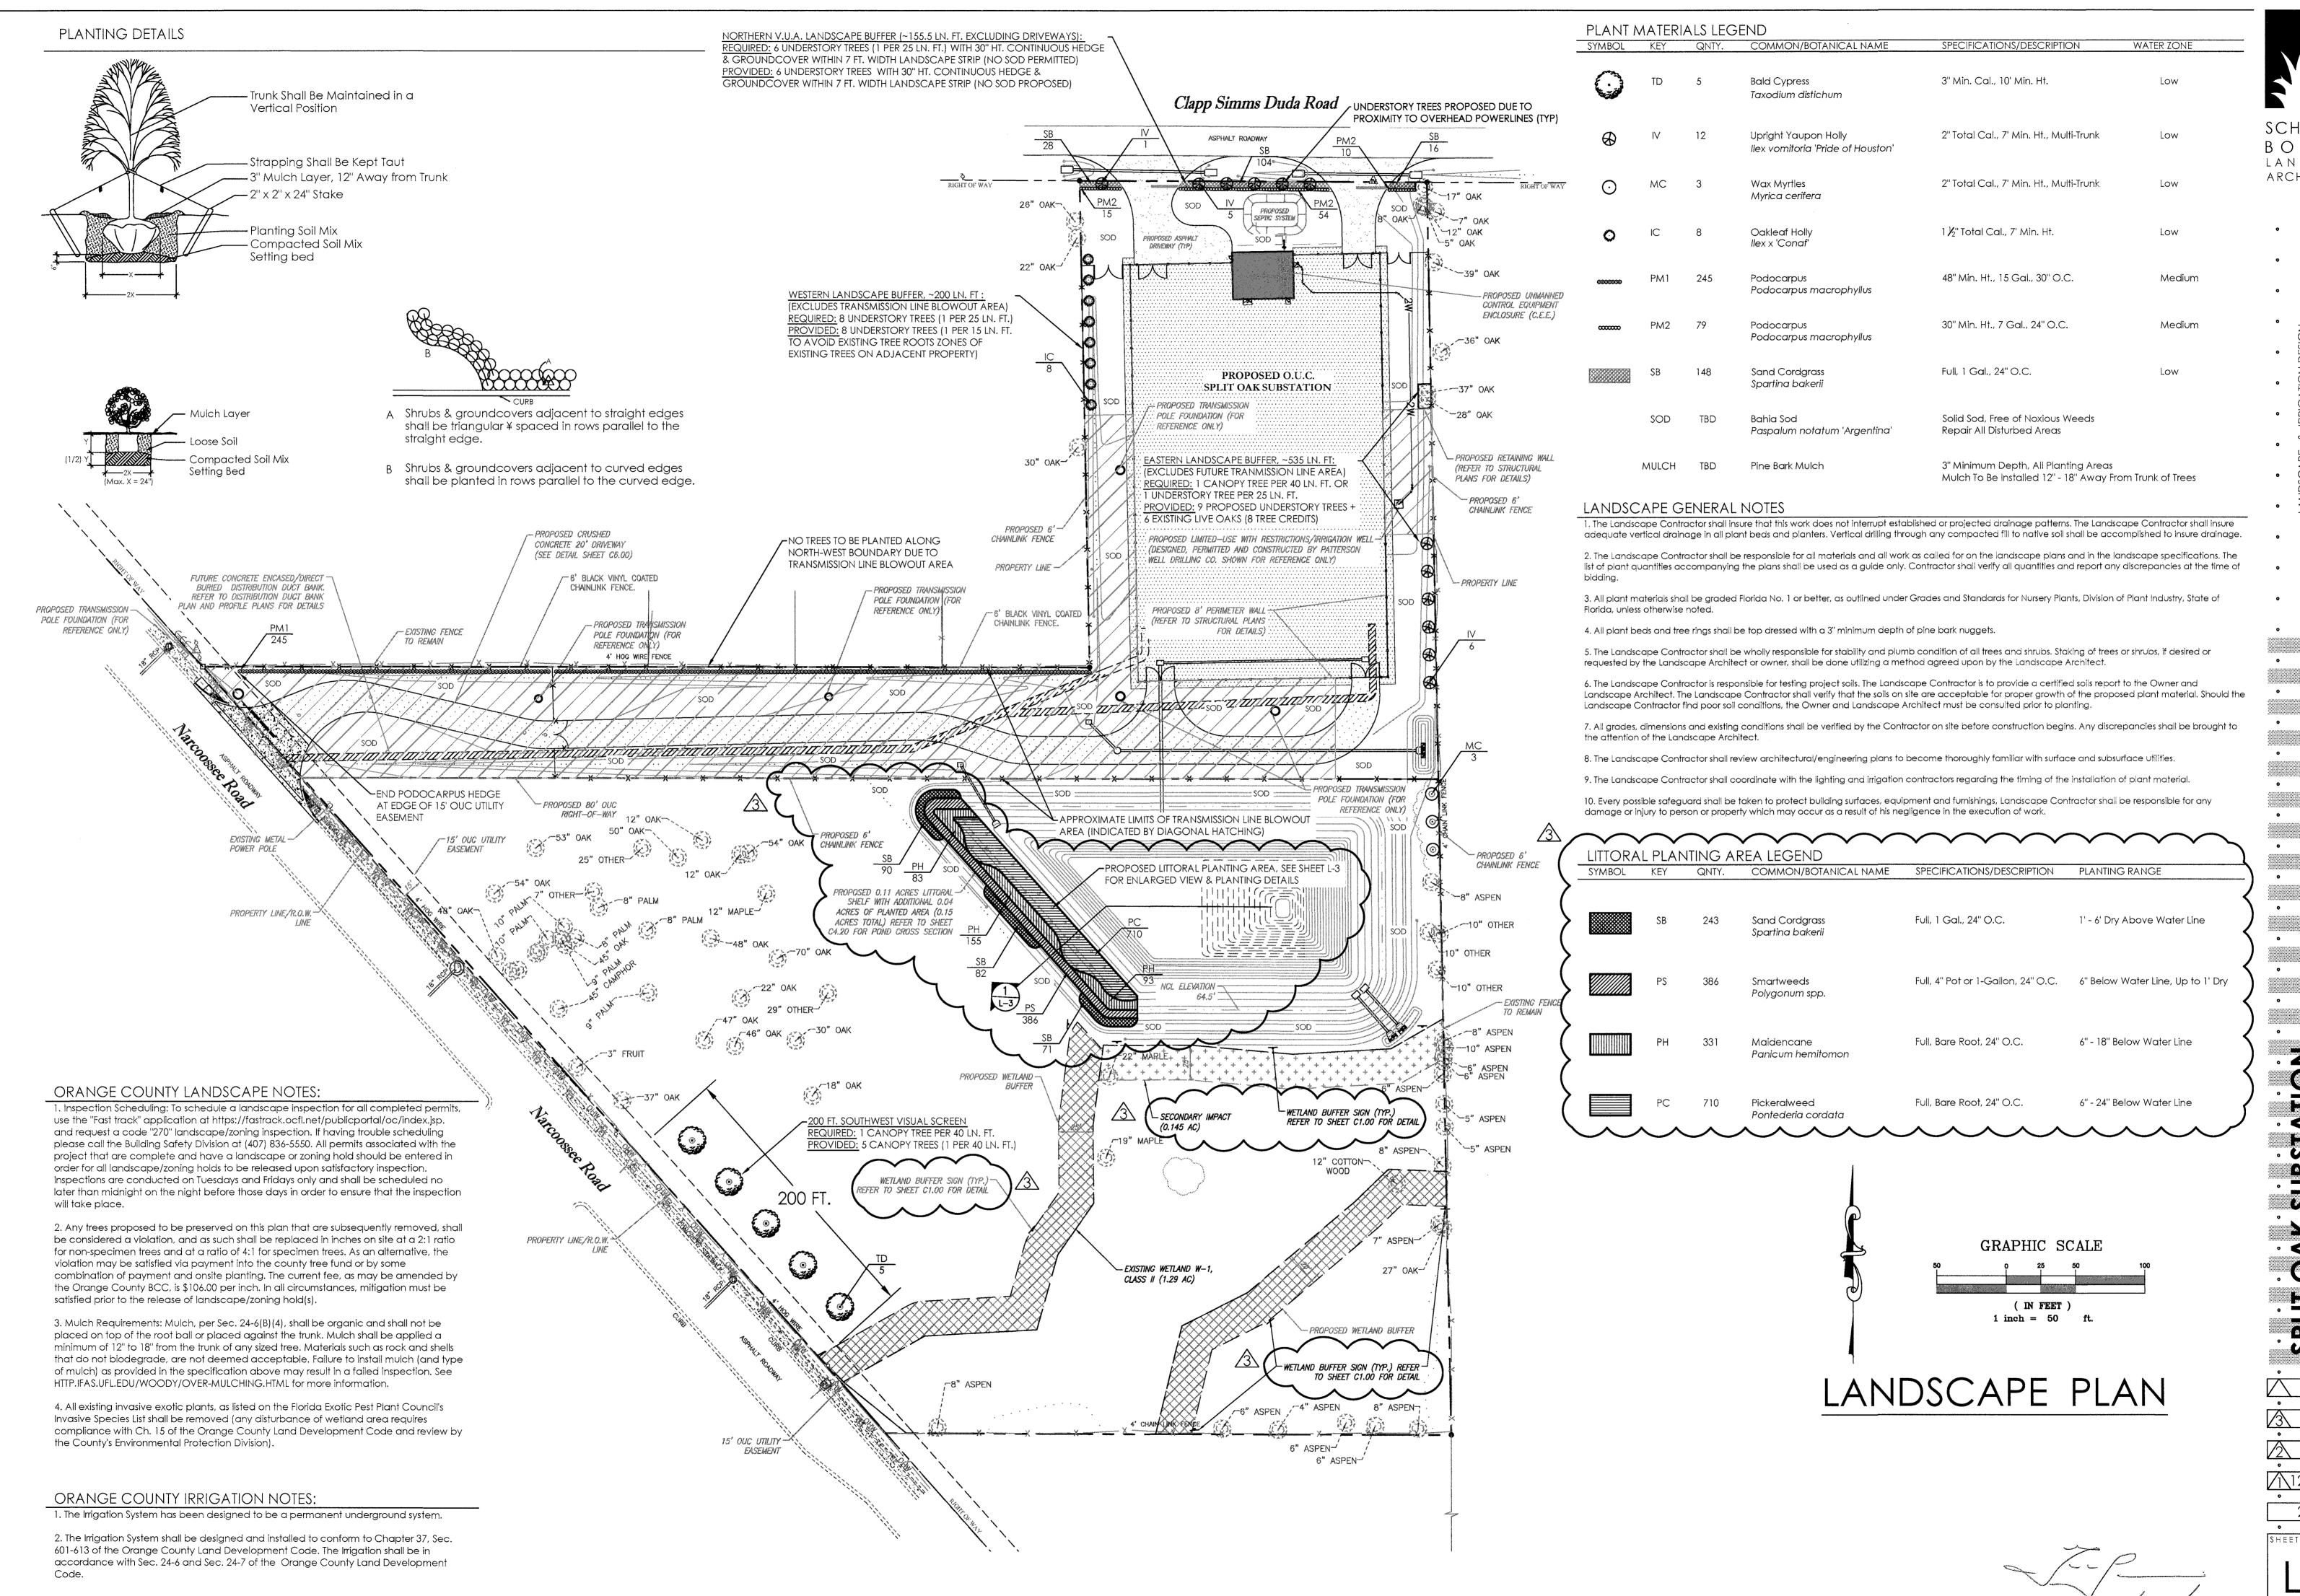

SCHWEIZER BOJACK LANDSCAPE ARCHITECTURE

1/13/21 /1\12/17/20

2/12/20

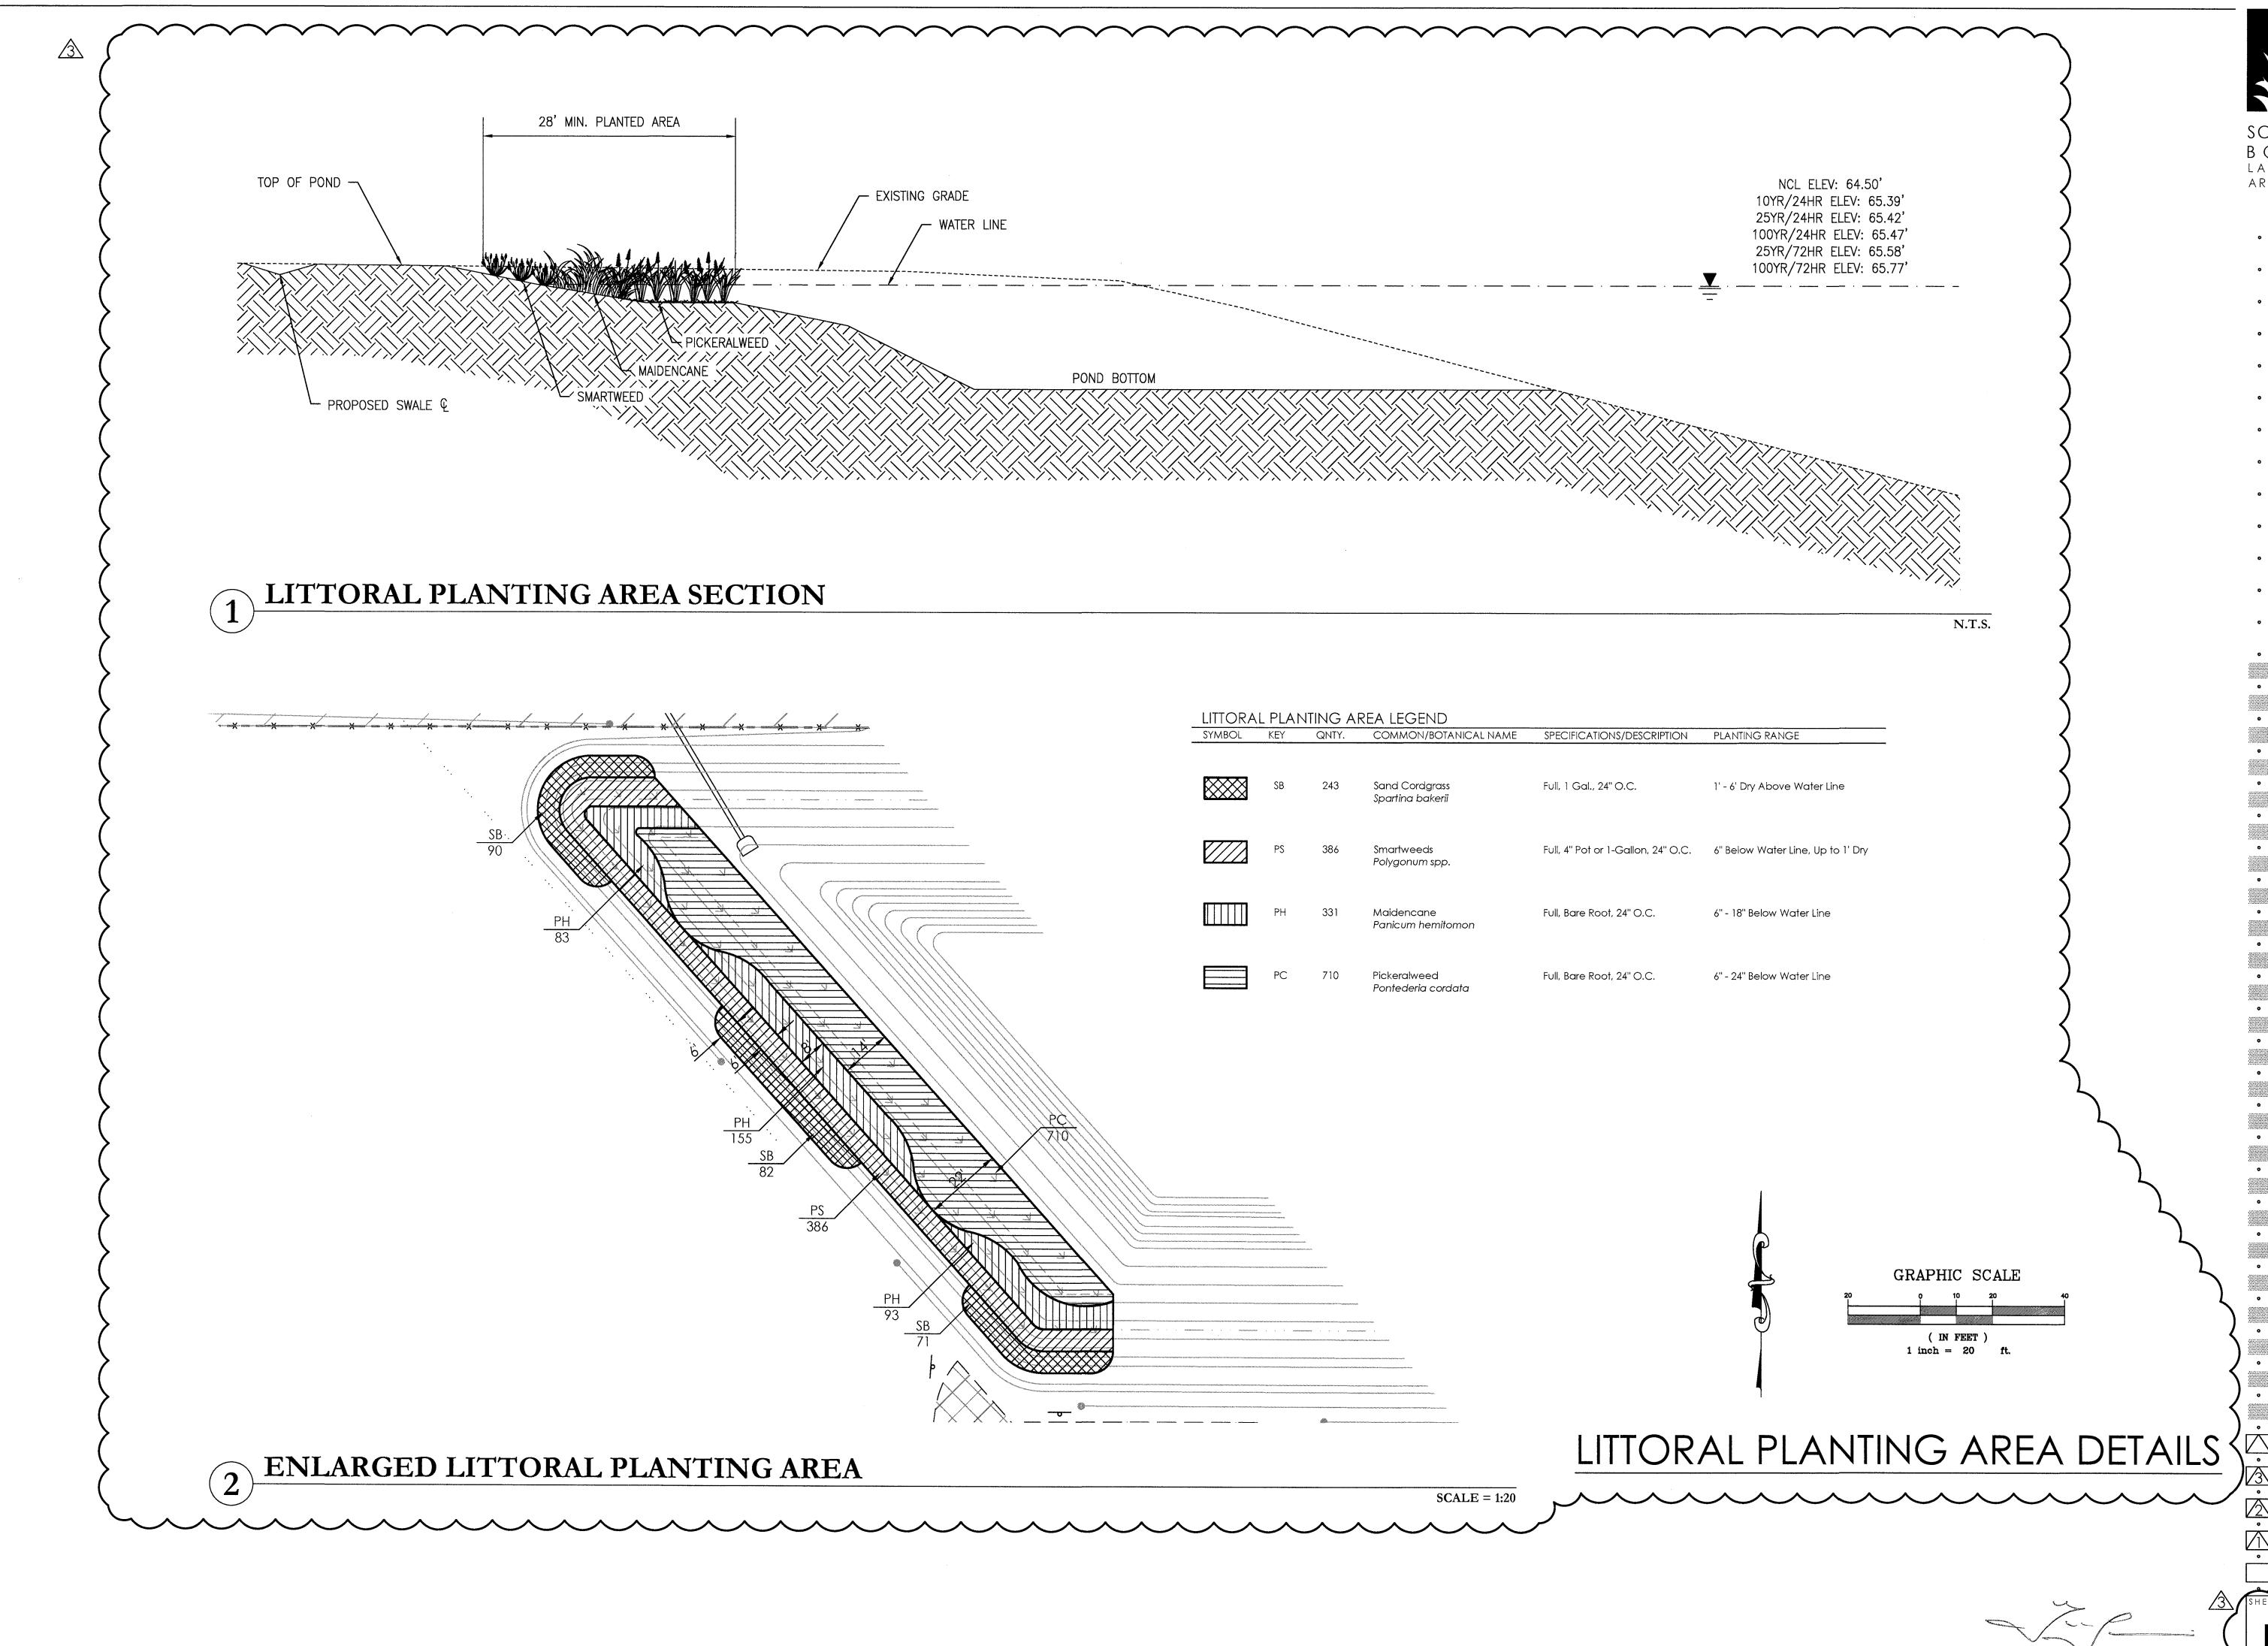

SCHWEIZER
BOJACK
LANDSCAPE
ARCHITECTURE

LANDSCAPE & IRRIGATION DESIGN (948383 • MAITLAND, FLORIDA 32794 • PH. (407) 376-1423 NSE NO. LC26000487 • DESIGN@SCHWEIZERBOJACK.COM

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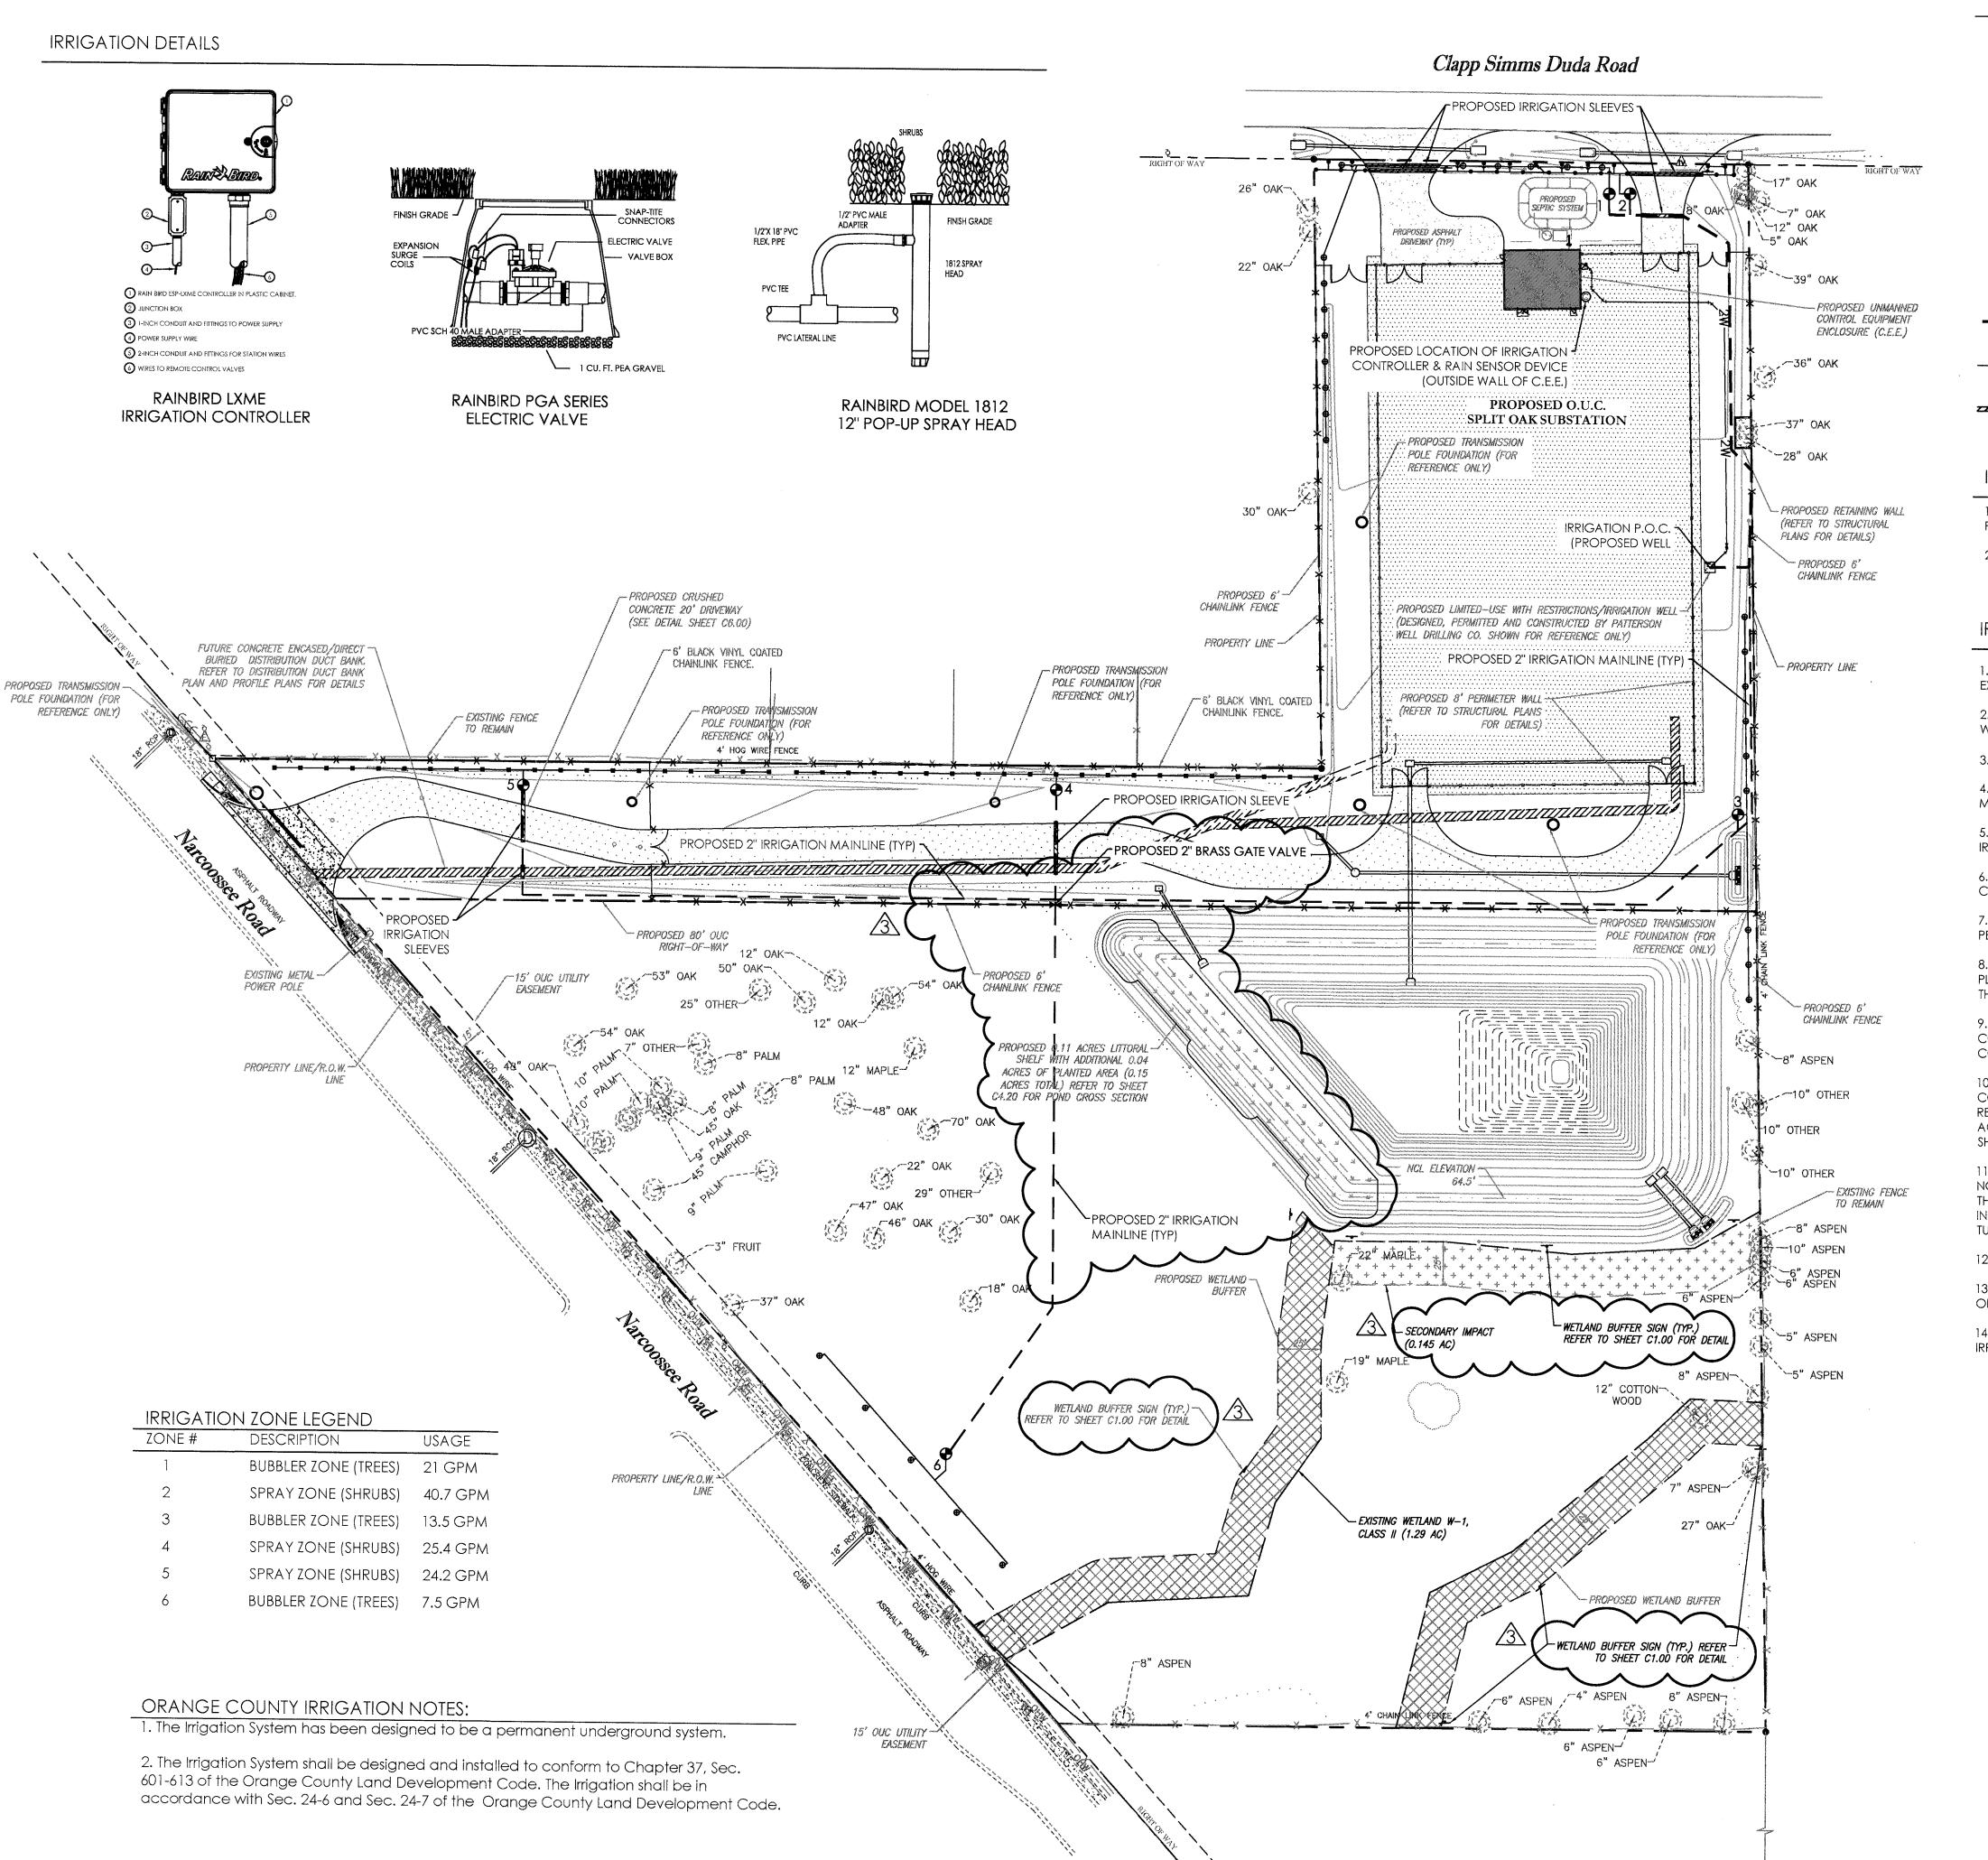
AKSUBSTATIC

SPLIT OAL

7/14/2 1/13/2 1/17/20

2/12/20 EET NUMBER

L-3



IRRIGATION EQUIPMENT LEGEND

SYMBOL SPECIFICATIONS/DESCRIPTION

IRRIGATION CONTROLLER & RAIN CHECK DEVICE: RAINBIRD ESP-LMXE (4 STATION) OUTDOOR MODULAR CONTROLLER INSTALLED ON EASTERN WALL OF C.E.E. WITH A MINI-CLIK II RAIN SENSOR GROUND WITH A MINIMUM OF 8' COPPER CLAD ROD.

RAINBIRD 1" PGA ELECTRIC VALVE INSTALLED IN AN AMETEK 10" VALVE BOX (NOTE: RAINBIRD 1.5" PGA ELECTRIC VALVE TO BE INSTALLED FOR IRRIGATION ZONE #2)

(NOTE: RAINBIRD 1.5 FGA ELECTRIC VALVE TO BE INSTALLED FOR IRRIGATION 2

2" BRASS GATE VALVE INSTALLED IN A RECTANGULAR VALVE BOX

RAINBIRD BUBBLER (INSTALLED USING A 🔏 FLEX PIPE WITH A MINIMUM OF 12" LENGTH)

RAINBIRD 1812-PRS 12" POP-UP SPRAY HEADS WITH 15-H NOZZLES

RAINBIRD 1812-PRS 12" POP-UP SPRAY HEADS WITH 15-SST NOZZLES

2" IRRIGATION MAINLINE (CLASS 200 PVC)

IRRIGATION LATERAL LINES (TO BE SIZED & INSTALLED BY IRRIGATION CONTRACTOR)

SCH. 40 IRRIGATION SLEEVES (TO BE BURIED A MINIMUM OF 18" DEPTH AND SIZED TWO TIMES LARGER THAN THE PIPE SIZE).

IRRIGATION CLARIFICATIONS:

1. AVOID CONFLICT WITH EXISTING AND PROPOSED UNDERGROUND UTILITIES AND EXISTING TREES DURING INSTALLATION OF THE PROPOSED IRRIGATION SYSTEM. FIELD ADJUST LAYOUT AS NECESSARY.

2. TREE BUBBLERS & SHRUB/GROUNDCOVER SPRAYS DESIGNED TO BE ON SEPARATE ZONES.

IRRIGATION GENERAL NOTES

1. THE IRRIGATION CONTRACTOR SHALL REFER TO THE LANDSCAPE PLAN WHEN TRENCHING TO LAY PIPE TO AVOID NEW AND EXISTING TREES AND LARGE SHRUBS.

2. ALL WIRING FROM THE IRRIGATION CONTROLLER TO THE REMOTE CONTROL VALVES SHALL BE UF-14/1 DIRECT BURIAL CABLE. ALL WIRE SPLICES SHALL BE MADE IN VALVE BOXES ONLY USING RAINBIRD SNAP-TITE CONNECTORS AND SEALANT.

4. ALL MAINLINE PIPING SHALL BE BURIED TO HAVE A MINIMUM COVER OF 18 INCHES, ALL LATERAL PIPING DOWNSTREAM OF THE MAINLINE SHALL BE BURIED TO HAVE A MINIMUM COVER OF 12 INCHES.

5. THE IRRIGATION CONTRACTOR SHALL COORDINATE WITH THE OWNER OR ARCHITECT ON THE EXACT LOCATION OF THE IRRIGATION CONTROLLER.

6. THE IRRIGATION CONTRACTOR SHALL VERIFY ALL CONDITIONS AND DIMENSIONS SHOWN ON THE PLANS AT THE SITE PRIOR TO COMMENCEMENT OF WORK UNDER THIS CONTRACT.

7. ALL IRRIGATION INSTALLATION SHALL CONFORM TO LOCAL CODES AND REGULATIONS, INCLUDING OBTAINING REQUIRED PERMITS FROM THE FLORIDA HEALTH DEPARTMENT.

8. ALL PIPING ON THE PLANS IS DIAGRAMMATICALLY ROUTED FOR CLARITY AND SHALL BE ROUTED TO AVOID NEW AND EXISTING PLANTS. DESIGN MODIFICATIONS SHALL ONLY BE MADE AS NECESSARY TO MEET FIELD CONDITIONS AND ONLY UPON APPROVAL OF THE LANDSCAPE ARCHITECT.

9. THE IRRIGATION CONTRACTOR SHALL CHOOSE THE APPROPRIATE NOZZLES TO PROVIDE MAXIMUM COVERAGE. THE IRRIGATION CONTRACTOR SHALL BE RESPONSIBLE FOR THE FINAL ADJUSTMENT OF THE SPRINKLERS ARC AND RADIUS TO ASSURE 100 PERCENT COVERAGE.


10. 115 VOLT, SINGLE PHASE ELECTRICAL POWER IS REQUIRED TO OPERATE THE IRRIGATION CONTROLLER. THE IRRIGATION CONTRACTOR SHALL BE RESPONSIBLE FOR COORDINATING THE LOCATION OF THE POWER WITH THE OWNER OR OWNER'S REPRESENTATIVE. IT SHALL BE THE RESPONSIBILITY OF THE IRRIGATION CONTRACTOR TO SEE THAT THE CONTROLLER IS WIRED IN ACCORDANCE WITH ALL ELECTRICAL CODES BY A LICENSED ELECTRICIAN. ALL MATERIALS NECESSARY TO WIRE THE CONTROLLER SHALL BE FURNISHED BY THE IRRIGATION CONTRACTOR.

11. ALL LANDSCAPE IRRIGATION SYSTEMS SHALL BE LOW-VOLUME. A LOW-VOLUME IRRIGATION SYSTEM IS DESIGNED TO PROVIDE NO MORE THAN THE MINIMUM AMOUNT OF WATER REQUIRED BY ANY SPECIFIC LANDSCAPE MATERIAL TO ENSURE SURVIVAL OF THAT MATERIAL. SUCH A SYSTEM UTILIZES A COMBINATION OF SPRINKLER MECHANISMS AND ZONES TO ACCOMMODATE THE INDIVIDUAL IRRIGATION REQUIREMENTS OF EACH TYPE OF LANDSCAPE MATERIAL, INCLUDING TREES, SHRUBS, ORNAMENTALS AND TURF AREAS.

12. ALL UNDERGROUND IRRIGATION SYSTEMS SHALL BE REGULATED BY AN AUTOMATIC TIMER OR CONTROLLER.

13. LOW TRAJECTORY HEADS OR LOW-VOLUME WATER DISTRIBUTING DEVICES SHALL BE USED TO IRRIGATE CONFINED AREAS IN ORDER TO PREVENT OVERSPRAY ONTO IMPERVIOUS AREAS.

14. AUTOMATICALLY CONTROLLED IRRIGATION SYSTEMS SHALL BE OPERATED BY AN IRRIGATION CONTROLLER THAT IS CAPABLE OF IRRIGATING HIGH REQUIREMENT AREAS.

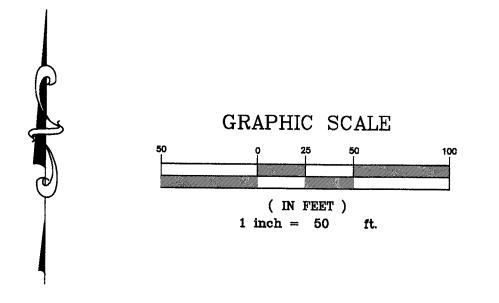

IRRIGATION PLAN

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SSTATION LORIDA

PLIT OAK SUB

7/14/21

1/13/21

2/12/20

SHEET NUMBER

L-4