# Interoffice Memorandum



Received on August 18, 2021 Publish: September 12, 2021 Deadline: September 7, 2021

August 18, 2021

To:

Katie Smith, Manager

Comptroller Clerk's Office

Through:

Cheryl Gillespie, Agenda Development Supervisor

Agenda Development

From:

David D. Jones, P.E., CEP, Manager

**Environmental Protection Division** 

(407) 836-1406

**Staff Person:** 

Elizabeth R. Johnson, CEP, Assistant Manager

**Environmental Protection Division** 

(407) 836-1511

Subject:

Request for Public Hearing on September 28, 2021, at 2:00 p.m., for a Shoreline Alteration/Dredge and Fill Permit Application (SADF-21-07-014) to construct a new seawall along the shoreline of the Lake Blanche/Lake Chase canal at 5614 Bay Side Drive, Orlando, FL 32819,

Parcel ID No. 21-23-28-5938-00-470, District 1

Applicants:

Mark and Becky Simmons

Type of Hearing:

Shoreline Alteration/Dredge and Fill Permit Application

Hearing required by

Florida Statute # or Code:

Chapter 33, Article IV, Windermere Water and Navigational

Control District

Advertising requirements:

Publish once in a newspaper of general circulation in Orange

County at least (7) seven days prior to public hearing.

Advertising timeframes:

At least (7) seven days prior to public hearing.

Abutters to be notified:

The applicants and the property owners within 500 feet of the project area will be notified at least (7) seven days prior to public

hearing by the Environmental Protection Division (EPD).

Lake Advisory Board

to be notified:

Windermere Water & Navigational Control District

Ijaz Ahmed (Chairman) – ijazahmed 736@gmail.com

September 28, 2021
Request for Public Hearing – Shoreline Alteration/Dredge and Fill Permit Application for Mark and Becky Simmons (SADF-21-07-014)
Page 2

Estimated time required

For public hearing:

2 minutes

Municipality or other Public Agency to be

notified:

South Florida Water Management District – <u>lprather@sfwmd.gov</u>

Hearing Controversial:

No

District #:

1

Materials being submitted as backup for public hearing request:

- 1. Site Plan
- 2. Location Map

#### Special Instructions to Clerk:

1. Once the Board of County Commissioners makes a decision on the Shoreline Alteration/Dredge and Fill Permit Application, please submit the decision letter to Liz Johnson with EPD. EPD will issue the decision to the applicant.

### Advertising Language:

1. Applicants, Mark and Becky Simmons, are requesting a Shoreline Alteration/Dredge and Fill Permit (SADF-21-07-014) to construct a new seawall along the shoreline of the Lake Blanche/Lake Chase canal pursuant to Chapter 33, Article IV, Windermere Water and Navigational Control District; 5614 Bay Side Drive, Orlando, Parcel ID No. 21-23-28-5938-00-470, District 1 (property legal description on file at EPD).

NS/NT/TMH/ERJ/DJ: jk

Attachments

# **Shoreline Alteration/Dredge and Fill Permit Request**



Shoreline Alteration/Dredge and Fill Permit Request SADF-21-07-014 District #1


**Applicants:** Mark and Becky Simmons

Address: 5614 Bay Side Drive

Parcel ID: 21-23-28-5938-00-470

**Project Site** 

**Property Location** 

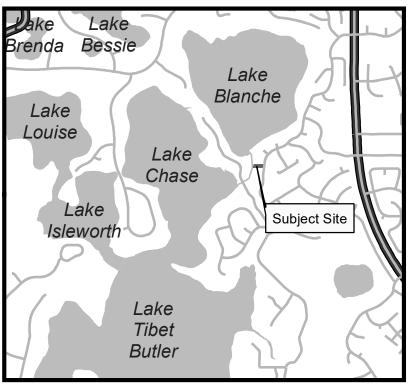

# Simmons Residence Dock



Specifications and Notations:

General Notes:

G1. These notes shall apply to all work in this set of drawings.

G2. It will be the responsibility of the contractor(s) to insure that all required permits are obtained and are in hand at the job site prior to the commencement of construction. Contractors shall abide by all conditions contained therein. G3. Prior to commencement, the contractor shall provide a construction schedule

for various site work elements so that site visits may be coordinated. G4. The contractor shall immediately notify the engineer of any discrepancies found between the drawings and the field conditions prior to construction in the

area impacted by the conflict. G5. In accordance with Florida Law (553.851) the contractor must notify the gas or other utility a minimum of 48 hours and a maximum of five days prior to

excavation. (Excluding weekends). G10. All requirements and recommendations of inspection personnel other than the owner's shall be reported to the engineer/owner prior to implementation. Compensation will not be allowed for work which is not authorized by the

engineer/owner. G11. All work shall be open to and subject to inspection by authorized personnel of the utility companies, project engineer and regulatory agencies.

agencies of proposed start up. All work shall be in accordance with their requirements; including but not limited to water, sewer, drainage, power, telephone, Gas and cable TV companies.

G12. Contractor shall notify all appropriate utility companies and water management

# Grading & Drainage Specifications:

1. In accordance with Florida Law (553.851) the contractor must notify the gas or other utility a minimum of 48 hours and a maximum of five days prior to excavation. (Excluding weekends).

2. Contractor shall verify all existing grades in the field and shall notify the engineer of any discrepancies prior to construction. 3. Where new earthwork meets existing, smoothly blend line and grade of existing and

new to provide vertical curves at the top and bottom of all slopes. 4. Excavation required within proximity of utility lines shall be done by hand.

Contractor shall repair any damage to existing utilities incurred during construction. 5. All points of construction ingress and egress shall be maintained to prevent tracking or flow of sediment onto public roads, adjacent wetlands or bodies of water.

# E — Erosion and Siltation Control

E1. A suitable perimeter silt fence shall be constructed and maintained for the duration of the project. The silt fence shall be built at the "silt fence line" as defined on the plans. Outlets and discharge points shall be protected with two layers of hay bales and filter cloth. Adjacent wetlands and open bodies of water, contractor must use a double fence separated by 5 feet. (See sheet for specific erosion control placement and

E2. Sod all disturbed areas not shown as landscaping, slopes 6:1 or greater, swales,

E3. Protect at all time against runoff or dewatering pollution of any downstream area or adjacent properties. Correct problems immediately.

> S 89°48'21" E 240.66'(P) S 89°45'59" E 200.48'(M) To Witness

> > One Story


Residence # 5614

# **Schedule of Drawings**

C1 - Cover Sheet & Site Plan


**Dock Installation Plan Elevations & Seawall Details** 



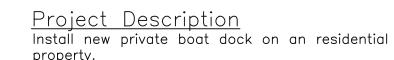

STR - 21/23/28 | Scale: N.T.S

Parcel ID: 21-23-28-5938-00-470

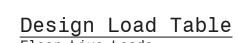

Orlando, Florida 32869

Ph (407) 299-0650

Floor Live Loads Decks & Walkways - 60 psf - 20 psf

Wind Design Data Ultimate Wind Speed - 139 mph Basic Wind Speed Risk Category - II Wind Exposure - D

Exposure Class Not Enclosed Int pressure Coeff - 0.55+/-

Peak Wind Load - 35.99 psf

## Project Data

**General Information** Total Site Area 21,923 sf (0.50 Ac) Width at NHWL:

Construction Data Construction Type: V Building Description: PT Wood Building Area:

Applicable Codes Florida Building Code 2020

<u>Wood Frame Construction Notes:</u> a. Design Parameters: per Load Table

b. Lumber exposed to weather or contacting concrete or steel shall be

pressure treated (PT)

c. All lumber in contact with concrete products shall be shielded by a protective barrier.

d. All fasteners in contact with pressure treated lumber are to be hot dipped galvanized or stainless steel


e. All dimensions shall be field verified. The engineer and owner shall be notified immediately of any discrepancies from dimensions or field

conditions noted herein. Elevation views are for visual reference only. Always refer to layout plans

dimensional discrepancies shall be brought to the attention of the engineer

for specified measurements. Anchor positions shall have a tolerance of  $\pm \frac{1}{2}$ ". Written dimensions supercede scaled dimensions in all cases. Any

<u>Dock Area Calculations</u>	
Length of property at the NHWL	- 90 lf
Oock Area Calculation	

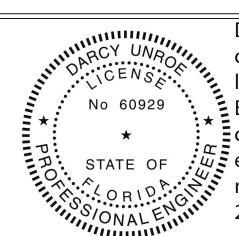



Darcy Unroe c=US, st=Florida, l=Orlando, o=Unroe Engineering, Inc, **∃**cn=Darcy Unroe, v ≤ email=Darcy@unroee ngineering.com 2021.08.13 07:57:24


This item has been electronically signed and sealed by Darcy Unroe, PE 60929 on the date indicated using a Digital Signature Printed copies of this document are not considered signed


|| Allowable area = (10sf/lf \* 75lf + (90-75)\*5sf/lf) - 825 sf Cantelever Roof (13x30) - 390 sf < 825 (OK)

and sealed and the signature must be verified on any electronic copy.

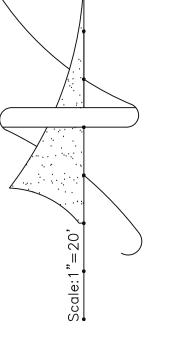


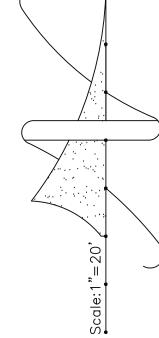

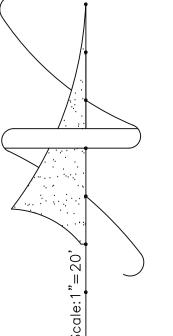

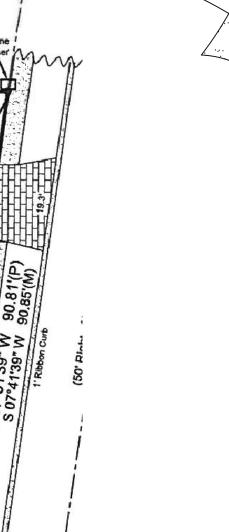

Fnd. 1/2" Rebar

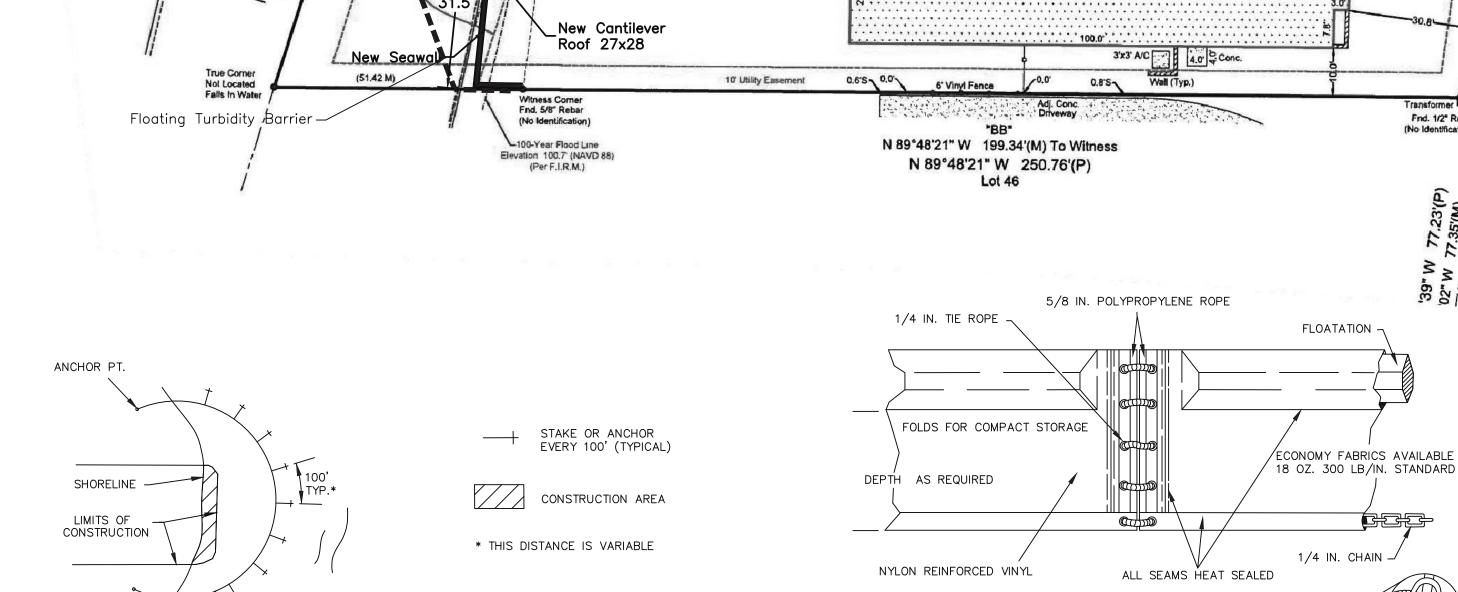

Lot 47

Deck 12x26

Pool

TYPICAL LAYOUTS OF FLOATING TURBIDITY BARRIERS STREAMS, PONDS, AND LAKES (PROTECTED AND NON-TIDAL)

ANCHOR PT.

# TYPE I FLOATING TURBIDITY BARRIER

(BLOW-UP OF SHACKLE CONNECTION) <

Floatation Material: Expanded Polyethylene Logs, 6" diameter, 55" Long, enclosed in 22 oz/sy PVC coated nylon or polyester (400 lbs min. tensile strength)

 $\frac{1}{4}$ " Galvanized steel chain.

Curtain Material: Silt film woven polypropylene (300 lbs min. tensile strength) Curtain Weight:


Revisions

eering, gin Ш Unroe



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Drawn Checked 1"=20' 07/27/21 Simmons-C1 Dwg. No.

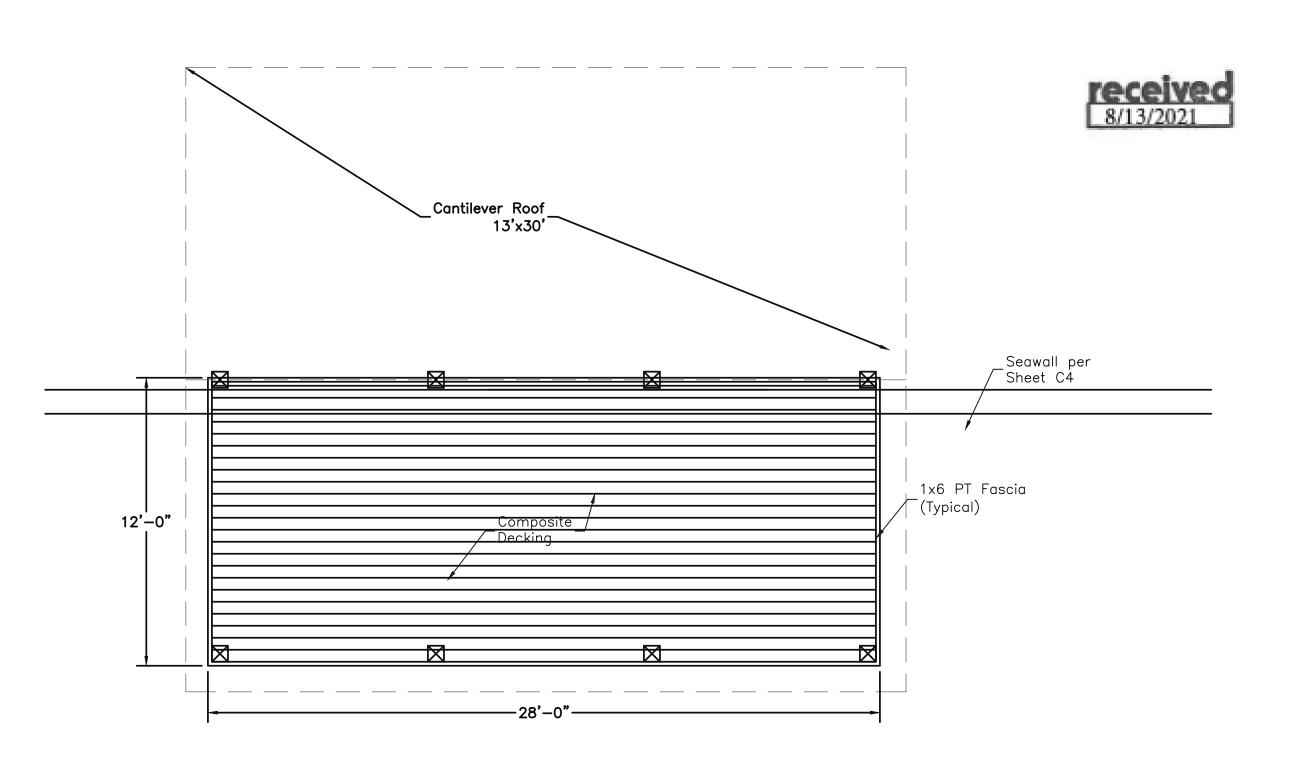

<u>Terminal Deck Plan</u> Scale: 1'=1/4"

Deck Framing Specifications Engineering Plan Framing Type

Conventional Hand Framed (Typ)

<u>Piles</u> #2 Grade Dense 6x6 Pressure Treated 0.60 CCA

Dock & Upper Level Framing
Girders & Joists shall be #2 Grade Type 1 2x8 Pressure Treated 0.40 CCA

Floor Decking 1x6 Composite Decking

Structural Connections Floor Frame to Pile Connection

 $\frac{3}{8}$ " H.D.G. Thru Bolts

# Roof Framing Specifications

<u>Piles</u> #2 Grade Dense 6x6 Pressure Treated 0.60 CCA

<u>Framing</u> Roof Headers

(2) 2x12 Pressure Treated 0.40 CCA Roof Decking ½" Zip Plywood

Bolting Roof Frame to Pile Connection

ALL HARWARE 1/2" THRU BOLTS

2,000LB CAPACITY PIPE BEARINGS

1/2 TON HOOK TYP

<u>Boat Hoist Detail</u>

4,000LB CAPACITY 1/4" S.S. CABLE

ACE 401 1HP HOIST MOTOR 4,000LB CAPACITY

 $4'-3\frac{1}{4}"$ 


7'-8<del>3</del>"

12**'**–0"


 $\frac{1}{2}$ " H.D.G. Thru Bolts

Bracing to Pile Connections ਤੂ" H.D.G. Lag Screws

Engineering Plan
Deck Framing Type
Conventional Hand Framed Roof Framing Type Pre-Engineered Trusses

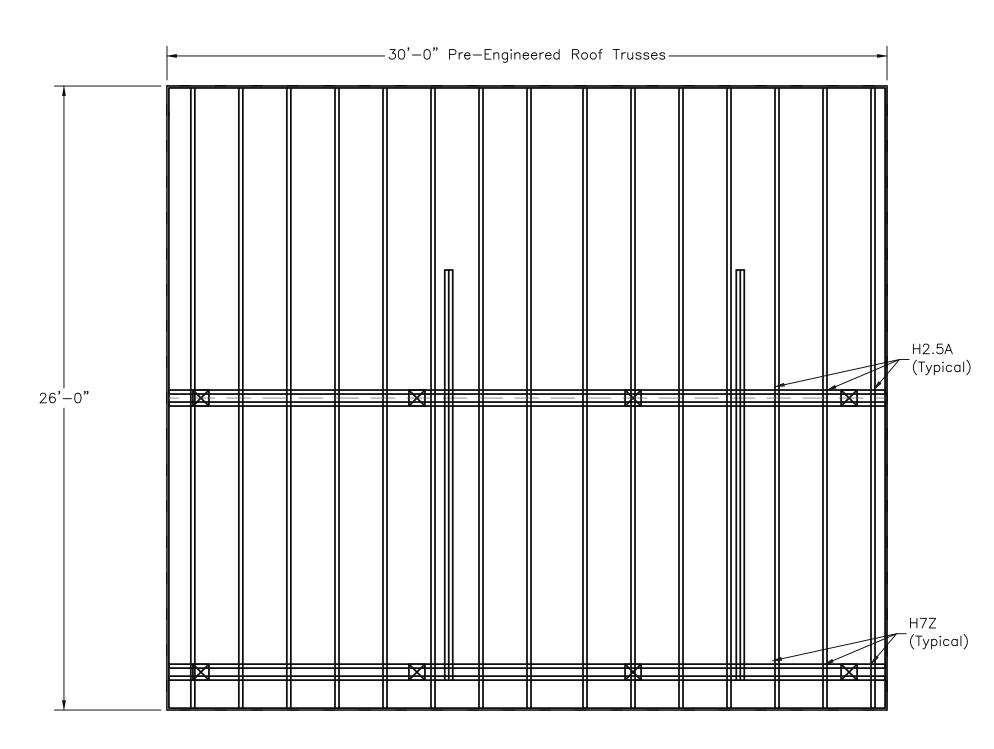

Roof Framing Plan Scale: 1'=1/4"

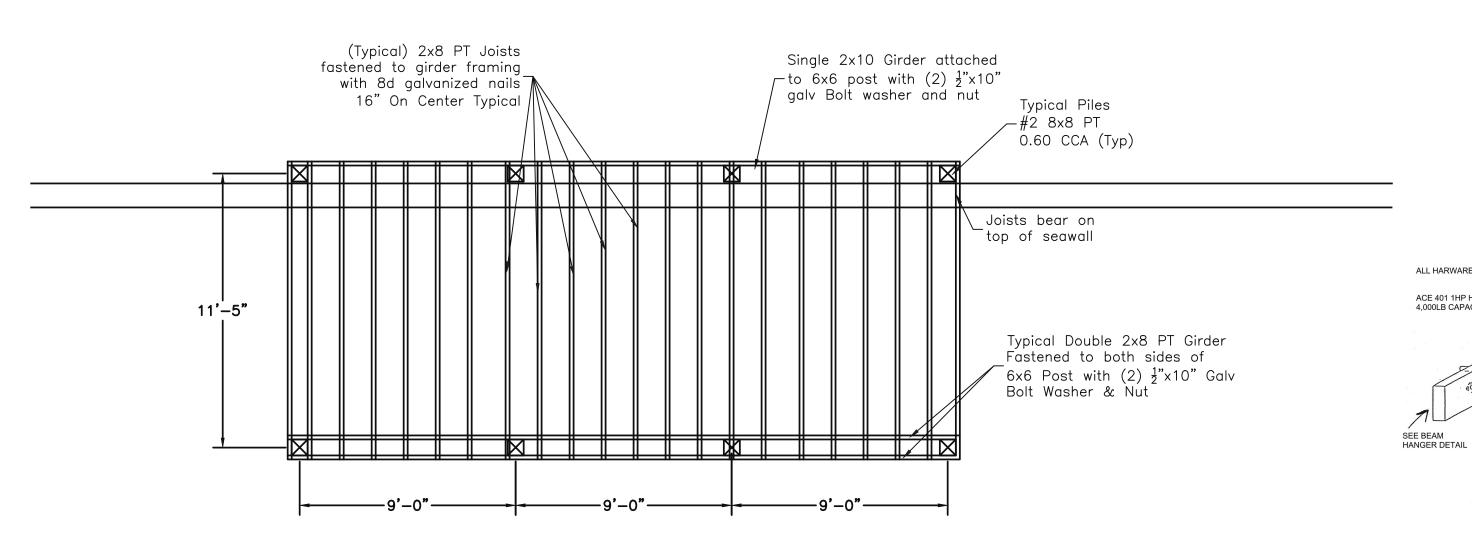

Terminal Framing Plan Scale: 1'=1/4"

←Rafters per plan

Structure Width


—25 yr Arch Shingles

-15 lb Felt over sheathing

 $-\frac{1}{2}$  Zip Plywood


<u>Roof Layering Detail — Shingle Roof</u>

→ Structure Length → ■

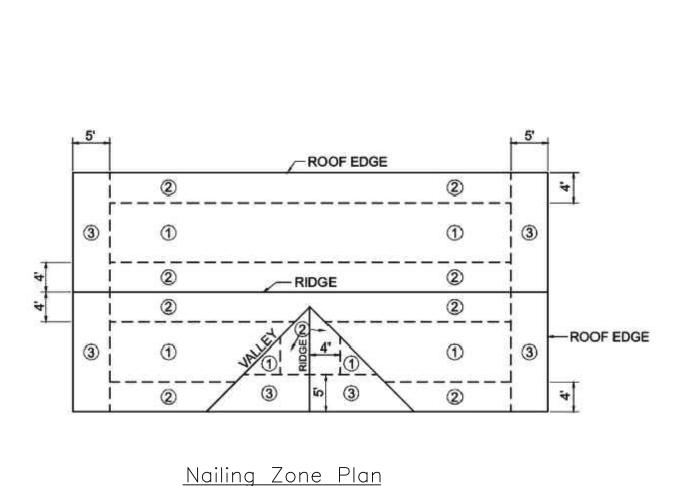


Roof Sheathing Nailing Zone Legend Zone 1 - Use 8d common nails 12' O.C. Zone 2 & 3 - Use 8d common nails 6" OC

For 1x6 T&G Roof decking, use one nail per joist in all zones.

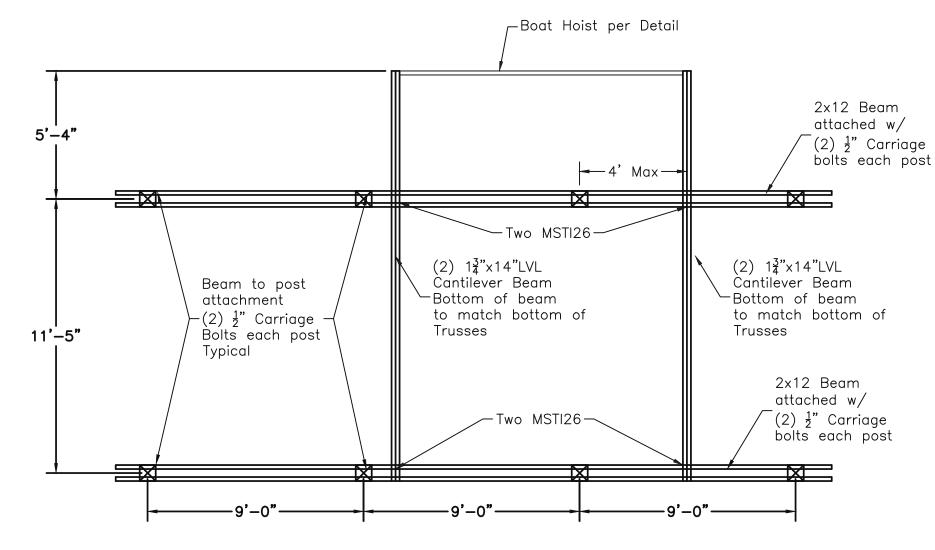

Roof Beam Plan Scale: 1'=1/4"

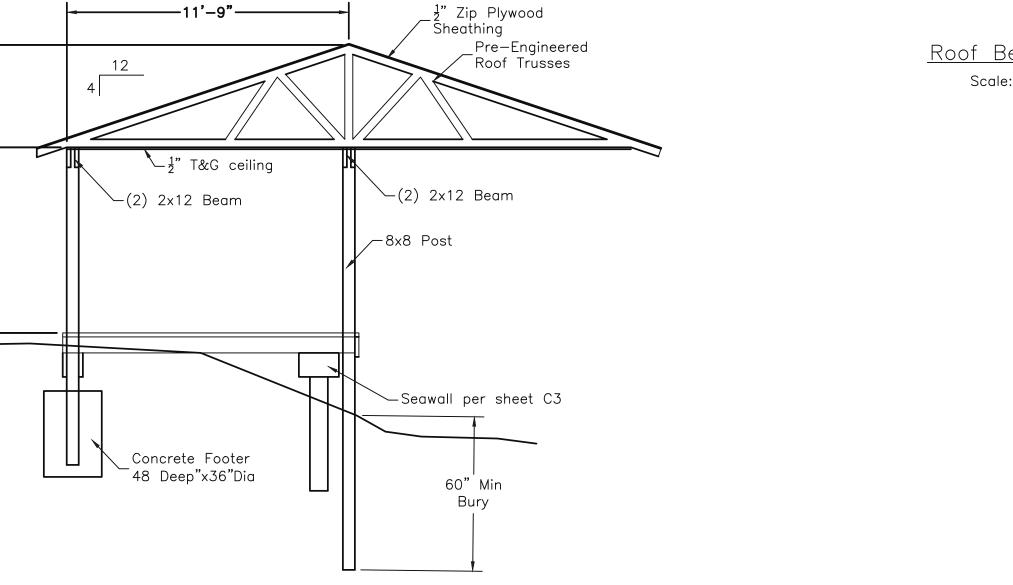


Construction Section Scale: 1'=1/4"


Cantilever Beams —

1,500LB CAPACITY "H" BEARING PULLEY

5LB WEIGHT TYP (OPTIONAL)

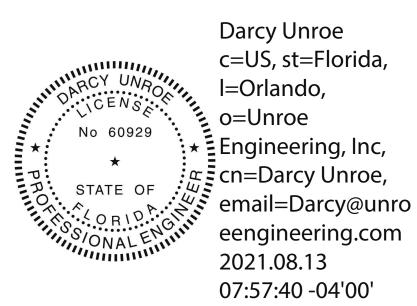

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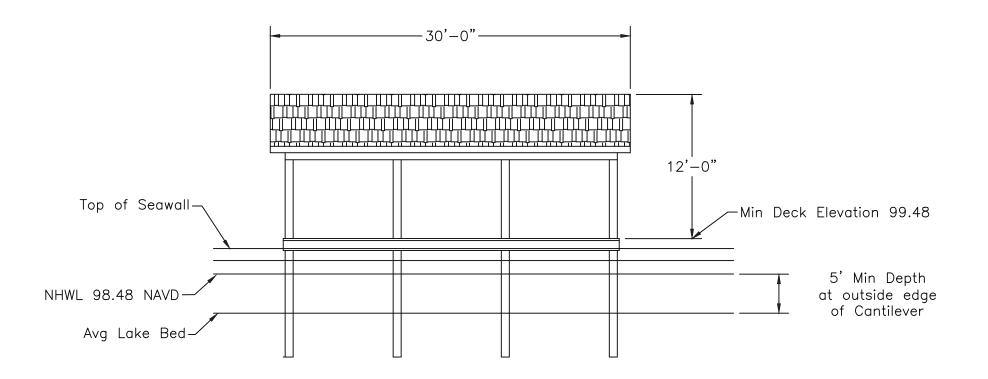
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Pla tallati CK

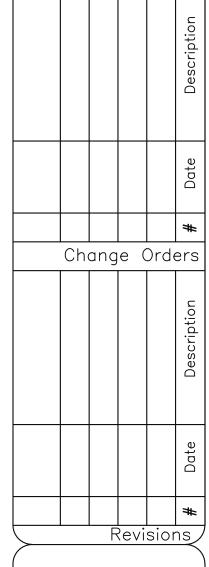
DP Drawn Checked Scale Per Plan 7/27/21 File Simmons-C2


Dwg. No.






# <u>Front Elevation</u>

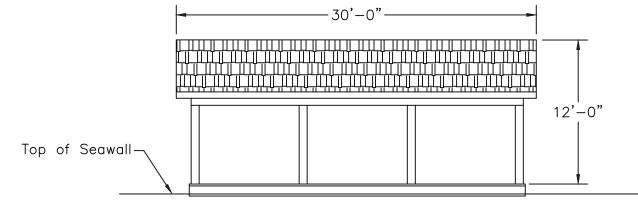


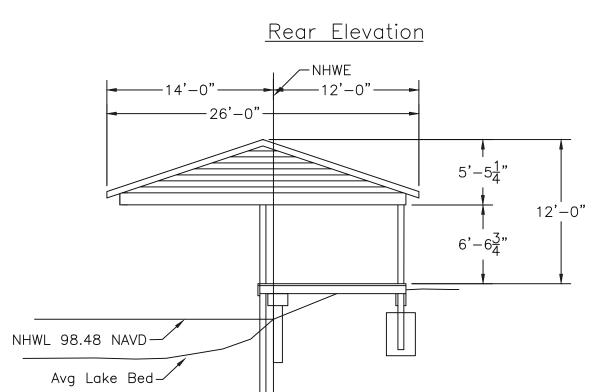


<u>Side Elevation</u>

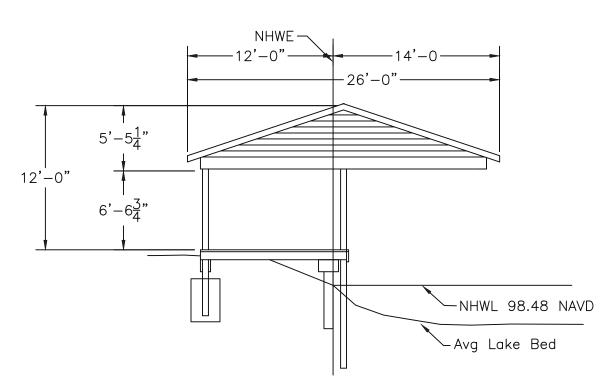


Side Elevation

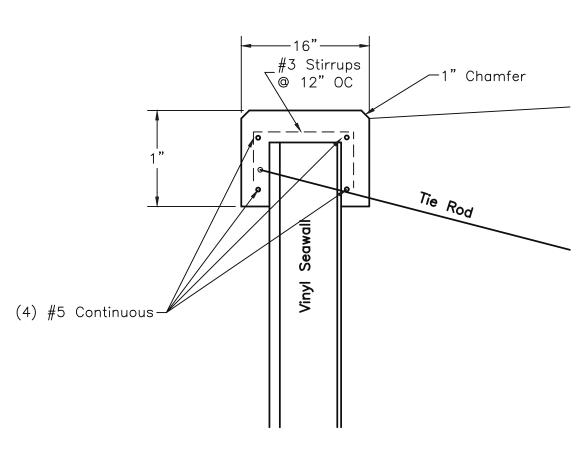


Top Cap Section

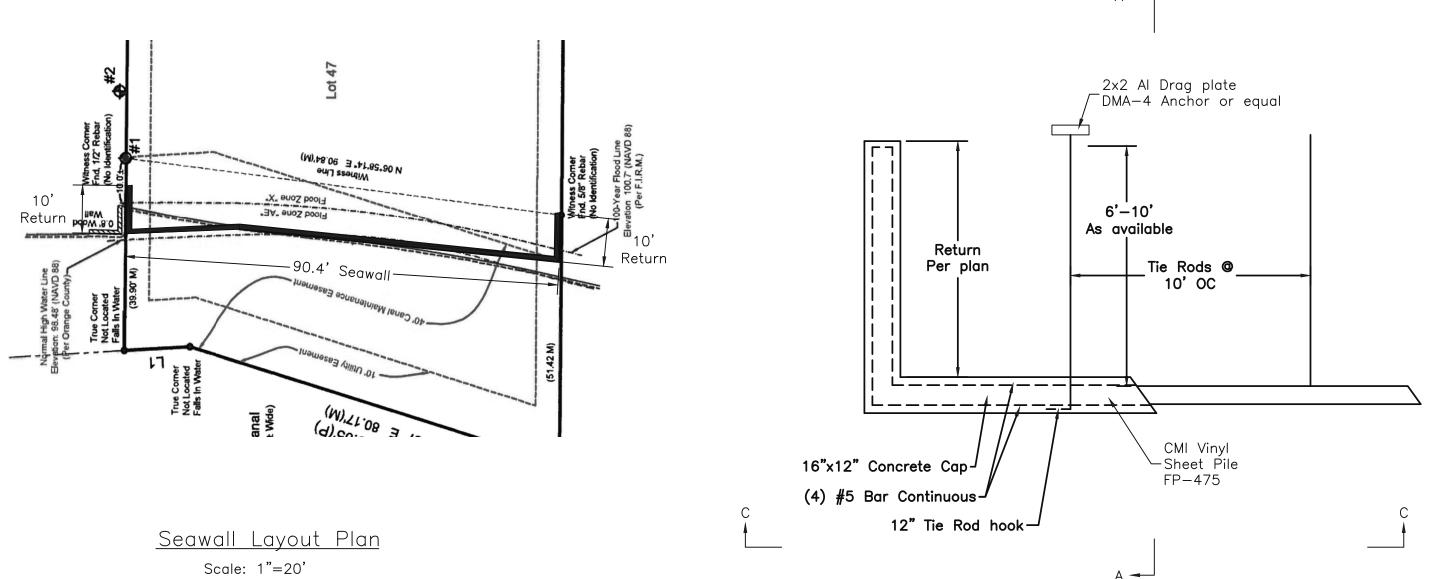

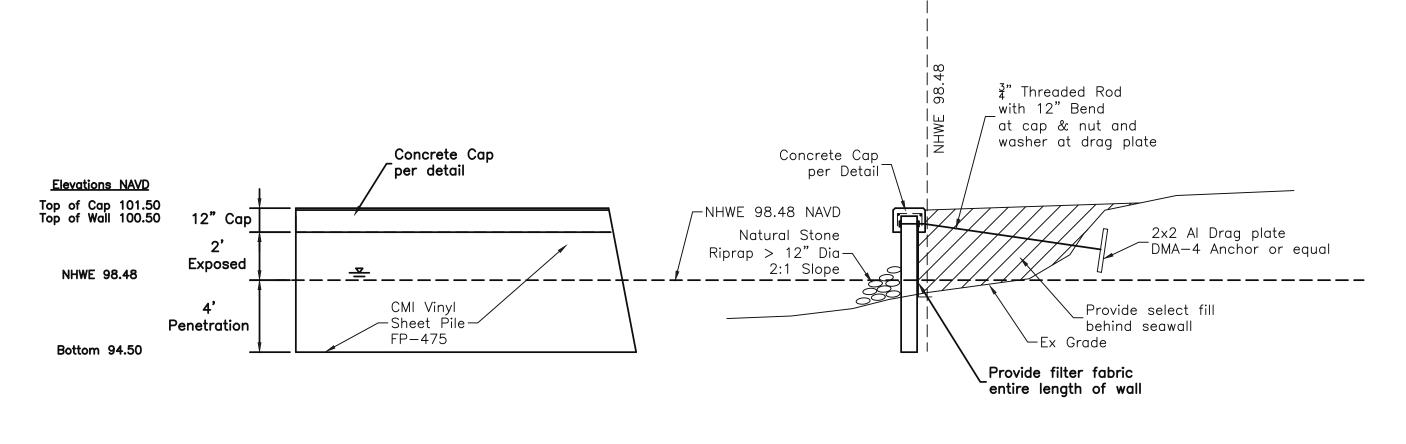

Elevation View (C-C) Scale: 1/4"=1'

Section View (A-A)

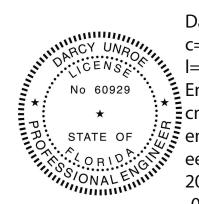

Darcy Unroe c=US, st=Florida, l=Orlando, o=Unroe Engineering, Inc, Ecn=Darcy Unroe, ຼ່ະພູ້ **ξ** email=Darcy@unro eengineering.com 2021.08.13 07:57:55 -04'00'

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electronic copy.

Details	Unroe Engineering,
e Dock	Civil Engineering/Planning/Scientific Evalu
	PO Box 690942, Orlando, FI 32869-C

Change Orders

Revisions

Seawall 00 ations Elev

Drawn Checked Scale Per Plan 7/27/21 Simmons-C3

Dwg. No.

